CREEKSIDE TOWNHOMES

GENERAL NOTES:

- 1. THESE DOCUMENTS & THE DESIGN THEY REPRESENT ARE THE PROPERTY OF SIMONSON & ASSOCIATES ARCHITECTS LLC. NO CHANGES TO THESE DOCUMENTS EITHER IN WHOLE OR IN PART MAY BE MADE IN ANY WAY WITHOUT THEIR PRIOR KNOWLEDGE & WRITTEN CONSENT
- 2. REFER TO ADDITIONAL NOTES AND LEGENDS ON ALL OTHER DOCUMENTS
- 3. REFER TO CIVIL, GEOTECHNICAL, ENVIRONMENTAL, STRUCTURAL, FIRE SUPPRESSION, PLUMBING, MECHANICAL, ELECTRICAL, COMMUNICATIONS, ELECTRONIC SAFETY & SECURITY DOCUMENTS FOR ADDITIONAL INFORMATION OR REQUIREMENTS. REFERENCE TO OTHER DISCIPLINES IS CONCEPTUAL FOR PURPOSES OF COORDINATION WITH ARCHITECTURAL DESIGN ONLY.
- 4. BEFORE COMMENCEMENT OF ANY WORK, CONTRACTOR SHALL GIVE ALL NOTICES AND OBTAIN ALL PERMITS. CONTRACTOR SHALL COMPLY WITH ALL APPLICABLE CODES, LAWS, ORDINANCES, RULES, REGULATIONS, REQUIREMENTS OF GOVERNING AGENCIES AND AUTHORITIES, HAZARDOUS MATERIAL APPLICATION AND DISPOSAL REQUIREMENTS, ETC.
- 5. THE ADA OR ADAAG IS A CIVIL RIGHTS ACT AND IS SUBJECT TO LEGAL INTERPRETATION THROUGH THE JUDICIAL PROCESS. REASONABLE CARE WAS EXERCISED IN INTERPRETING THE GUIDELINES AND ALL GUIDELINES MAY NOT BE INDICATED ON THESE PLANS: HOWEVER, FAILURE TO IDENTIFY A GUIDELINE DOES NOT GIVE THIS CONTRACTOR THE RIGHT TO VIOLATE THEM. THE CONTRACTOR MUST COMPLY WITH AI GUIDELINES AS REQUIRED BY THE ADAAG
- . THESE DRAWINGS REPRESENT THE COMPLETED PROJECT, AT TIME OF SUBSTANTIAL COMPLETION. THE INTENT OF THE DRAWINGS IS TO INCLUDE ALL ITEMS NECESSARY FOR THE PROPER EXECUTION AND COMPLETION OF THE WORK. UNLESS OTHERWISE NOTED, THEY DO NOT REPRESENT THE MEANS AND METHODS OF CONSTRUCTION. SEQUENCING AND MEANS AND METHODS OF CONSTRUCTION SHALL BE THI SOLE RESPONSIBILITY OF THE GENERAL CONTRACTOR.
- THESE DRAWINGS DO NOT CONTAIN INFORMATION WITH REGARD TO CONSTRUCTION SAFETY PROCEDURES. THE CONTRACTOR IS SOLELY RESPONSIBLE FOR ALL CONSTRUCTION SAFETY AND SHALL PERFORM ALL WORK IN ACCORDANCE WITH GOVERNING AUTHORITIES CONSTRUCTION SAFETY GUIDELINES.
- 8. PROVIDE COMPLETE IN PLACE ALL LABOR, TRANSPORTATION, MATERIAL, TAXES, FEES, PERMITS, LICENSES, INSURANCE, UTILITIES, INSPECTIONS, EQUIPMENT, MACHINERY, SUPERVISION, AND OTHER ITEMS NECESSARY TO COMPLETE THE WORK IN STRICT COMPLIANCE WITH THE PLANS, DOCUMENTS AND SPECIFICATIONS PREPARED BY THE ARCHITECT AND APPROVED BY THE OWNER.
- 9. VERIFY EXISTING CONDITIONS PRIOR TO FABRICATION AND PRIOR TO PROCEEDING WITH THE WORK, AND NOTIFY THE ARCHITECT IMMEDIATELY OF SIGNIFICANT DISCREPANCIES WHICH MAY IMPACT AESTHETICS. DURABILITY, COST AND/OR SCHEDULES.
- 10. DO NOT SCALE DRAWINGS IN ORDER TO DETERMINE INTENDED LAYOUT OR DIMENSIONS. IF DIMENSIONS ARE IN QUESTION THE CONTRACTOR SHALL BE RESPONSIBLE FOR OBTAINING CLARIFICATION BEFORE CONTINUING WITH WORK. DRAWINGS ARE INTENDED ONLY AS A GRAPHICALLY CORRECT REPRESENTATION OF WORK TO BE ACCOMPLISHED.
- 11. THE CONTRACTOR SHALL PROTECT ALL EXISTING ENTITIES. REMOVE, REPLACE OR REPAIR MATERIALS, FACILITIES AND SERVICES DAMAGED DURING THE COURSE OF CONSTRUCTION TO THE SATISFACTION OF THE OWNER AND GOVERNING AUTHORITY.
- 12. ALL WORK SHALL BE OF GOOD QUALITY AND ALL MATERIALS AND EQUIPMENT SHALL BE NEW AND FREE FROM DEFECTS FOR A PERIOD OF 1 YEAR FROM THE DATE OF SUBSTANTIAL COMPLETION OF WORK. ANY EXTENDED WARRANTIES OBTAINED FROM SUPPLIERS OR SUBCONTRACTORS SHALL BE FORWARDED TO THE OWNER.
- 13. ALL REQUIREMENTS NOT FOLLOWED, INCLUDING SUBSTITUTIONS NOT PROPERLY APPROVED AND AUTHORIZED, IN WRITING, MAY BE CONSIDERED DEFECTIVE.
- 14. FAILURE TO IDENTIFY A STANDARD, RECOMMENDATION &/OR REQUIREMENT DOES NOT GIVE ANYONE THE RIGHT TO VIOLATE ANY CODE & GOVERNING AUTHORITY REQUIREMENTS, MINIMUM QUALITY OR QUANTITY REQUIRED, ASTM & OTHER INDUSTRY STANDARDS, MANUFACTURER RECOMMENDATIONS & REQUIREMENTS, ETC.
- 15. COMPLY WITH ALL WEATHER-RELATED CONSTRUCTION REQUIREMENTS. DO NOT BUILD WITH OR ON FROZEN, SATURATED, CONTAMINATED OR INAPPROPRIATE SUBSTRATES OR CONDITIONS. BUILD OVER DRY COMPACTED APPROVED GRADE WITH APPROVED APPROPRIATE MATERIALS.
- 16. PROVIDE POSITIVE DRAINAGE OF SURFACE WATER AWAY FROM AND OFF ALL BUILDINGS WITHOUT PONDING OR WATER ADJACENT TO OR ON BUILDINGS OR PAVEMENTS.
- 17. BY SUBMITTING SHOP DRAWINGS, PRODUCT DATA AND SAMPLES, THE GENERAL CONTRACTOR AND SUB-CONTRACTOR HAS VERIFIED AND APPROVED THE INFORMATION CONTAINED WITHIN. THE GENERAL CONTRACTOR'S REVIEW AND APPROVAL SHALL BE SHOWN ON EACH SUBMITTAL PRIOR TO THE SUBMISSION TO THE ARCHITECT.
- 18. THE GENERAL CONTRACTOR SHALL FORWARD TO SUBCONTRACTORS & SUPPLIERS, FULL SETS OF BIDDING &/OR CONSTRUCTION DOCUMENTS, INCLUDING, BUT NOT LIMITED TO, DRAWINGS, SPECIFICATIONS, ADDENDA, CLARIFICATIONS, BID FORMS, & ALL OTHER DOCUMENTATION ISSUED BY ARCHITECT & ARCHITECT'S CONSULTANTS TOWARD CONVEYING A COMPLETE & TIMELY PROJECT.

CLIENT

Hatch Development Group 1620 Pleasant St., Suite 123 Des Moines, IA 50314 (515) 314-5481 contact: Ryan Galloway e-mail: ryan@perennialproperties.com

ARCHITECT

Simonson & Associates Architects L.L.C. 1717 Ingersoll Avenue, Suite 117 Des Moines, IA 50309 (515) 440-5626 (515) 440-0964 Fax contact: Andy Lorentzen e-mail: alorentzen@simonsonassoc.com

ARCHITECT I hereby certify that the portion of this technical submission described below was prepared by me or under my direct supervision and responsible charge. I am a duly licensed architect under the laws of the State of Iowa.

Andrew P. Lorentzen IA Reg. #06680 June 30, 2023 Registration Expires

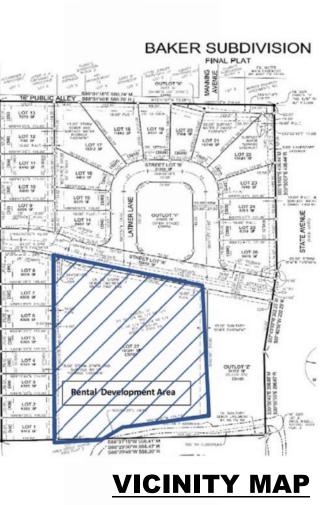
Signature Date Pages or Sheets covered by this seal: As listed above



DEVELOPMENT PROPOSAL FOR

321 STATE AVE. AMES, IA 50014







INDEX OF DRAWINGS

GENERAL

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G-101	RENDERINGS
G-102	SITE PLAN

ARCHITECTURAL

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A-103	FLOOR PLAN - BLDG 3
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A-203	EXTERIOR ELEVATIONS - BLDG 5 & 6
A-411	UNIT PLANS
A-412	UNIT PLANS
A-413	UNIT PLANS
A-414	UNIT PLANS

ENERGY

Refer to COMcheck Compliance Certificates. SPECIFICATION MANUAL Not Provided - All Specification Notes included on drawings.

DOCUMENTS BY OTHERS

GEOTECHNICAL INVESTIGATIONS (Refer to these condition documents under separate cover) ENVIRONMENTAL (Refer to these condition documents under separate cover) **CIVIL - LANDSCAPING** (Refer to these design documents under separate cover.) FIRE SUPPRESSION (Refer to these design documents under separate cover.)

PLUMBING

(Refer to these design documents under separate cover.) **HEATING, VENTILATING, & AIR CONDITIONING** (Refer to these design documents under separate cover.) ELECTRICAL (Refer to these design documents under separate cover.)

COMMUNICATIONS (Refer to these design documents under separate cover.)

ELECTRONIC SAFETY & SECURITY (Refer to these design documents under separate cover.)

> NOTE: ALL DESIGN DOCUMENTS ARE SUBJECT TO AUTHORITIES HAVING JURISDICTION REVIEW AND APPROVAL

LEGEND:

-) - DOOR INDICATOR

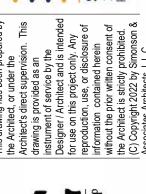
-) - FINISH INDICATOR

- KEYNOTE
- REVISION INDICATOR
- - ROOM INDICATOR
- HORIZONTAL & VERTICAL ASSEMBLY TYPE IDENTIFIER
- WINDOW INDICATOR

SCALE NOTE: 24"x36" SHEET (FULL SIZE) - SCALE IS AS NOTED.

12"x18" SHEET (HALF SIZE) - SCALE IS ONE-HALF OF WHAT IS NOTED OTHER SHEET SIZES NOT TO SCALE









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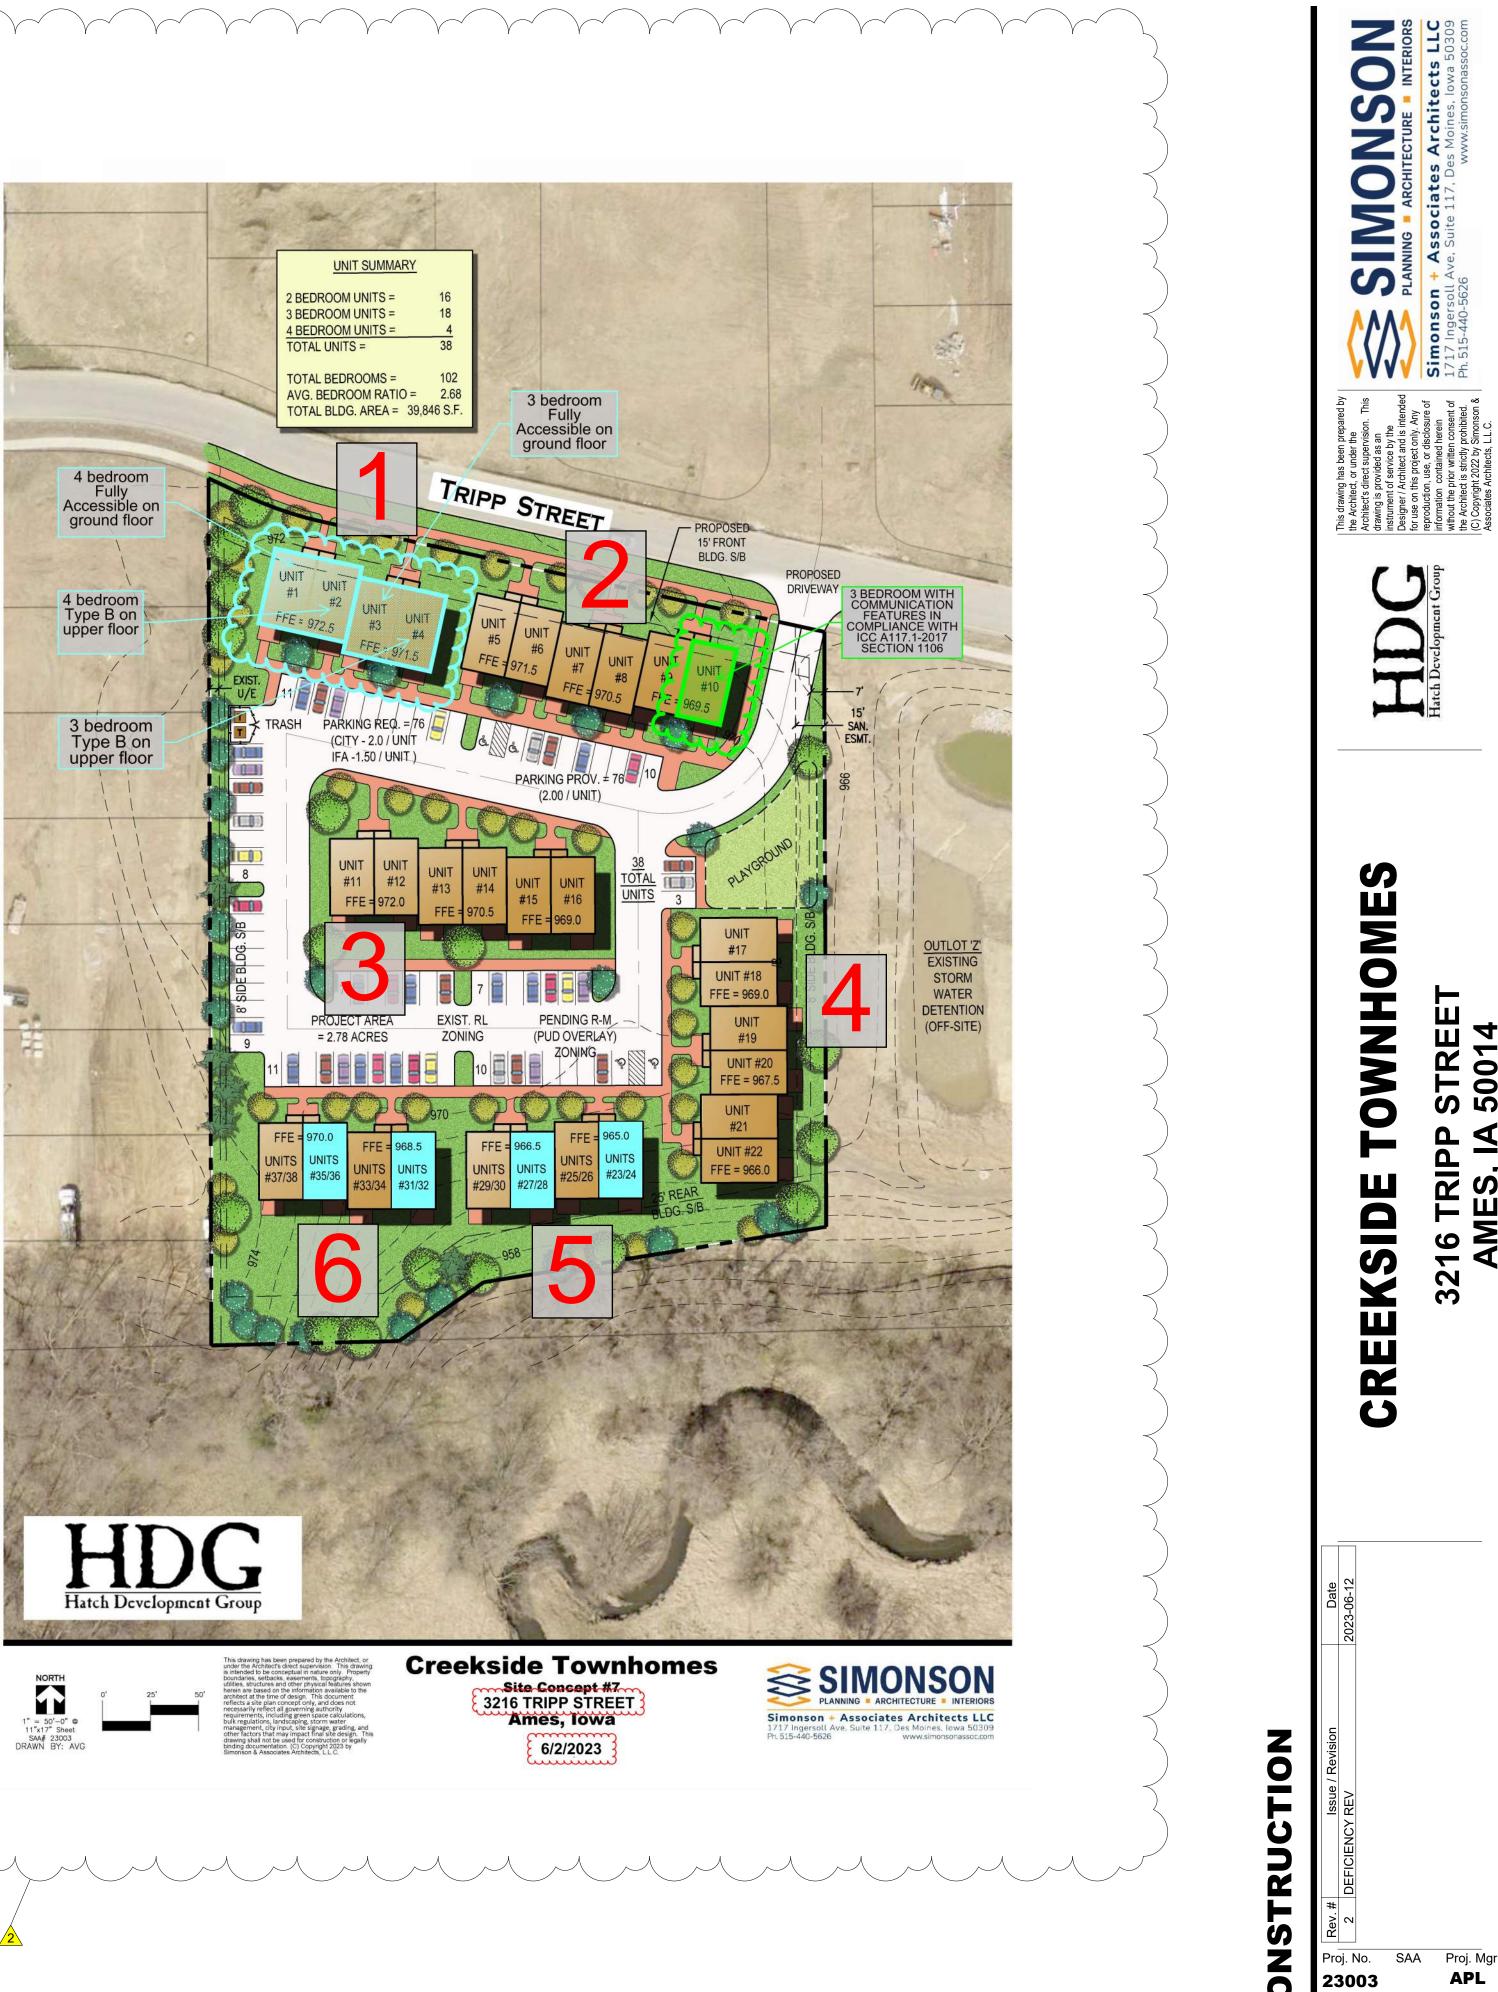
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		CF	REEKSIDE UNIT	SUMMARY		
BUILDING	UNIT NUMBER	AREA	BEDROOMS	BATHROOMS	FULLY ACCESSIBLE	TYPE B
1	1	1483	4	2	YES	
1	2	1554	4	2		YES
1	3	1372	3	2	YES	
1	4	1454	3	2		YES
2	5	1462	3	2	•••	YES
2	6	1462	3	2		YES
2	7	1462	3	2		YES
2	8	1462	3	2		YES
2	9	1462	3	2		YES
2	10	1462	3	2	•••	YES/COMI
3	11	1462	4	2	•••	YES
3	12	1462	3	2	•••	YES
3	13	1462	3	2	•••	YES
3	14	1462	3	2	•••	YES
3	15	1462	3	2	•••	YES
3	16	1462	3	2	•••	YES
4	17	1462	4	2	•••	YES
4	18	1462	3	2	•••	YES
4	19	1462	3	2	•••	YES
4	20	1462	3	2	•••	YES
4	21	1462	3	2	•••	YES
4	22	1462	3	2	•••	YES
5	23	800	2	1	YES	
5	24	869	2	1	•••	NO
5	25	800	2	1	•••	YES
5	26	869	2	1	•••	NO
5	27	800	2	1	YES	
5	28	869	2	1	•••	NO
5	29	800	2	1	•••	YES
5	30	869	2	1		NO
6	31	800	2	1	YES	
6	32	869	2	1		NO
6	33	800	2	1		YES
6	34	869	2	1		NO
6	35	800	2	1	YES	
6	36	869	2	1		NO
6	37	800	2	1		YES
6	38	869	2	1		NO



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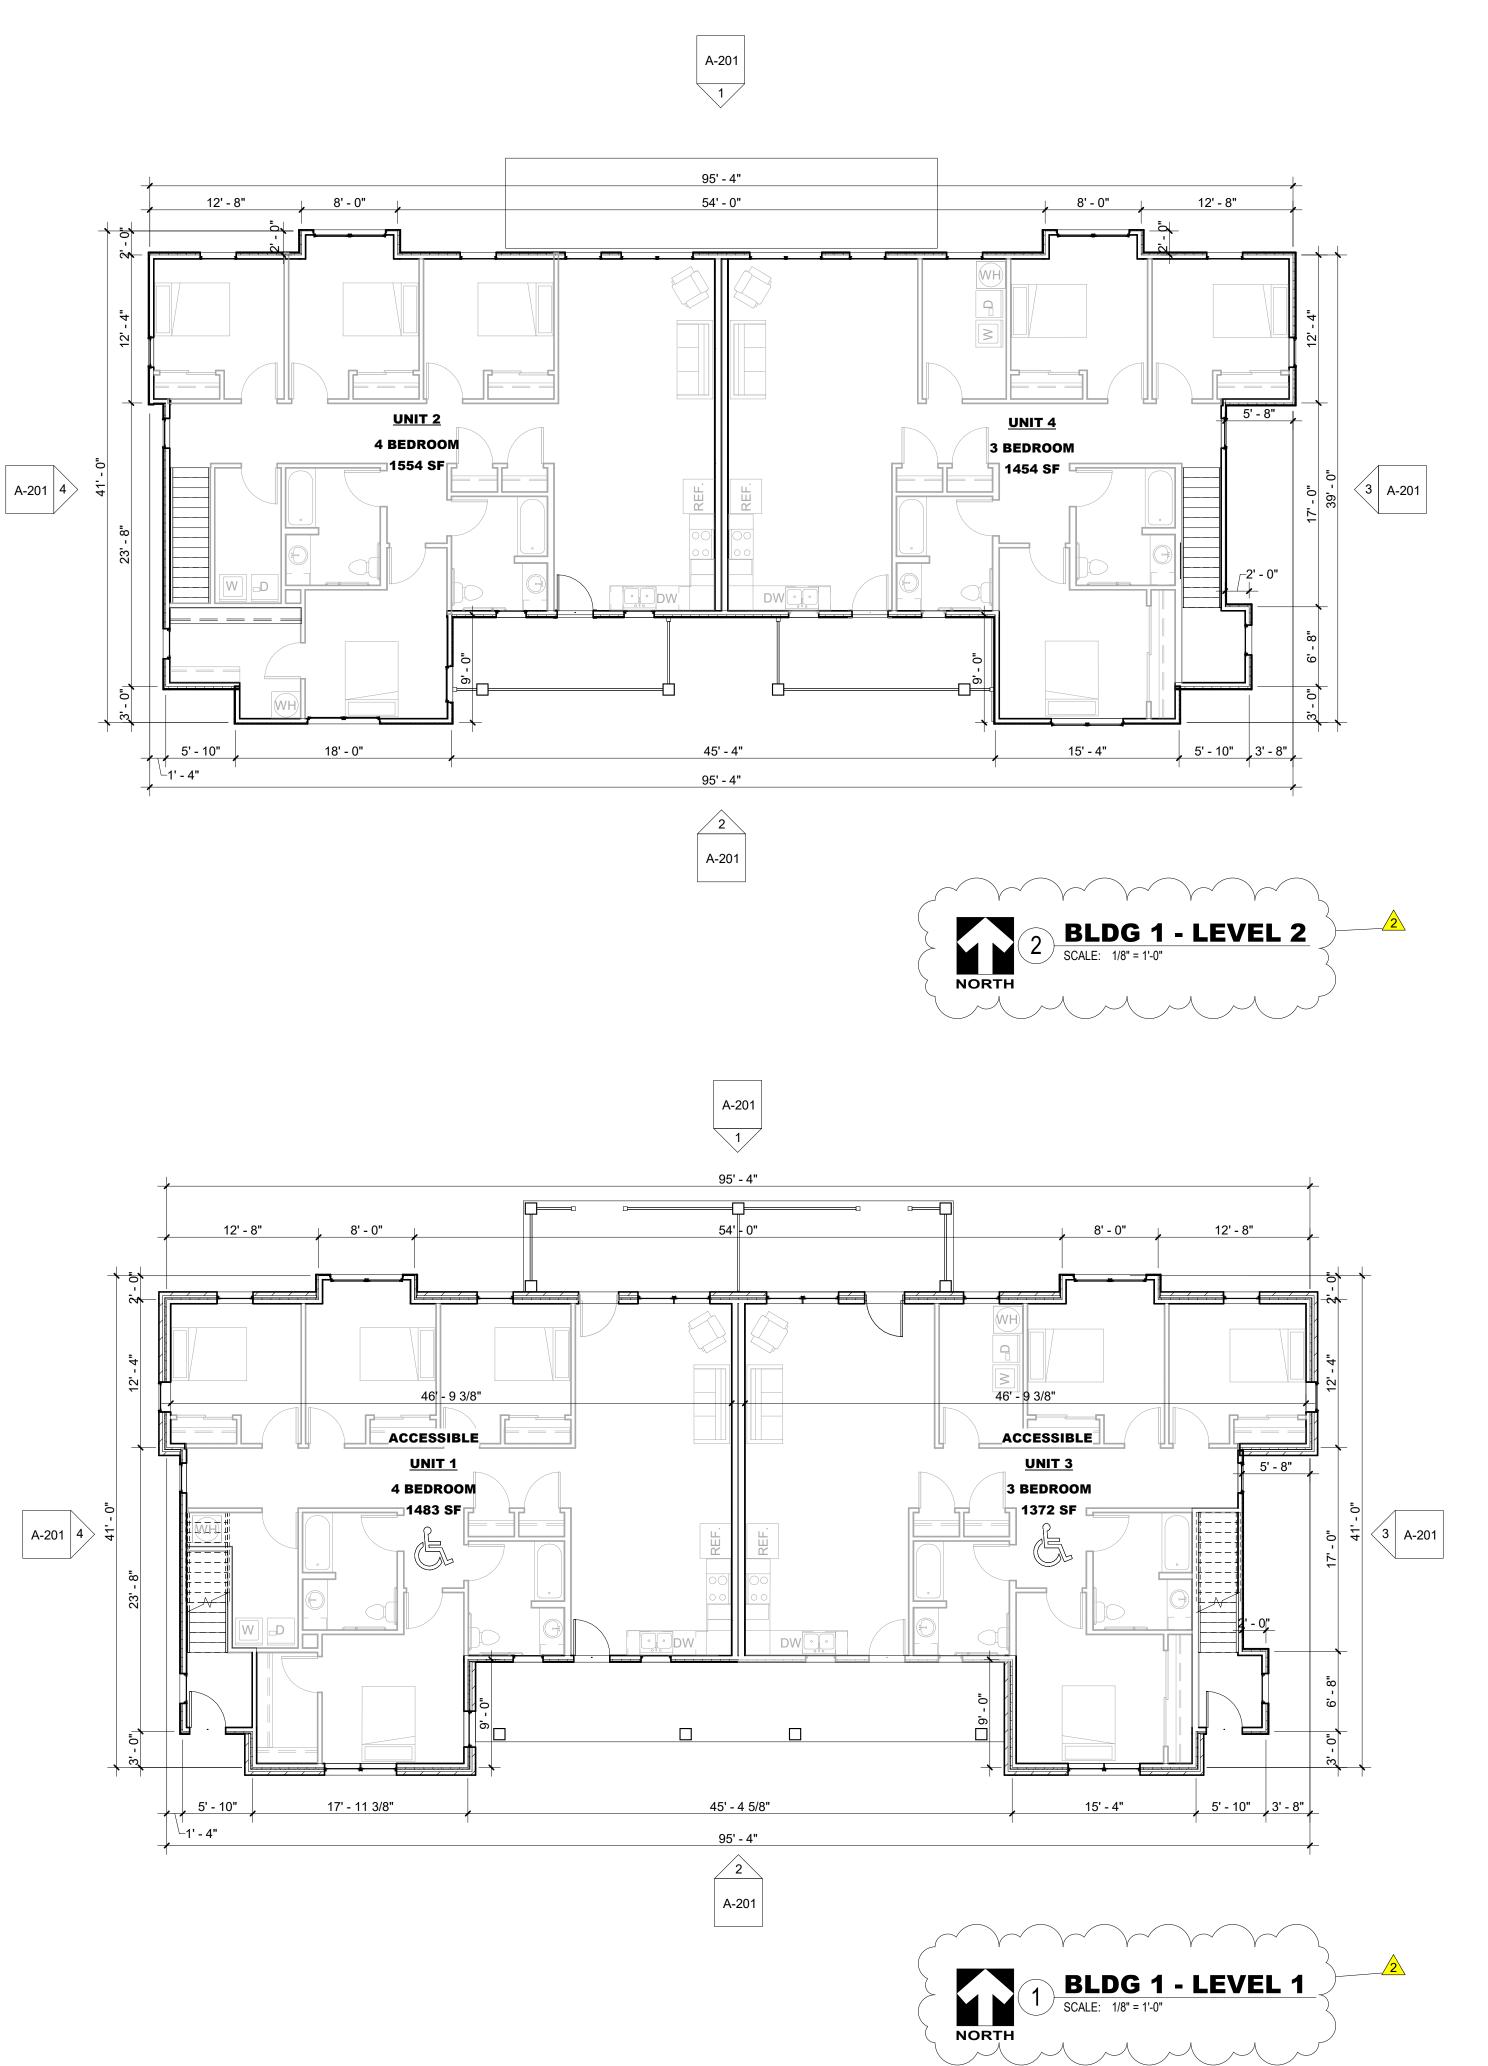
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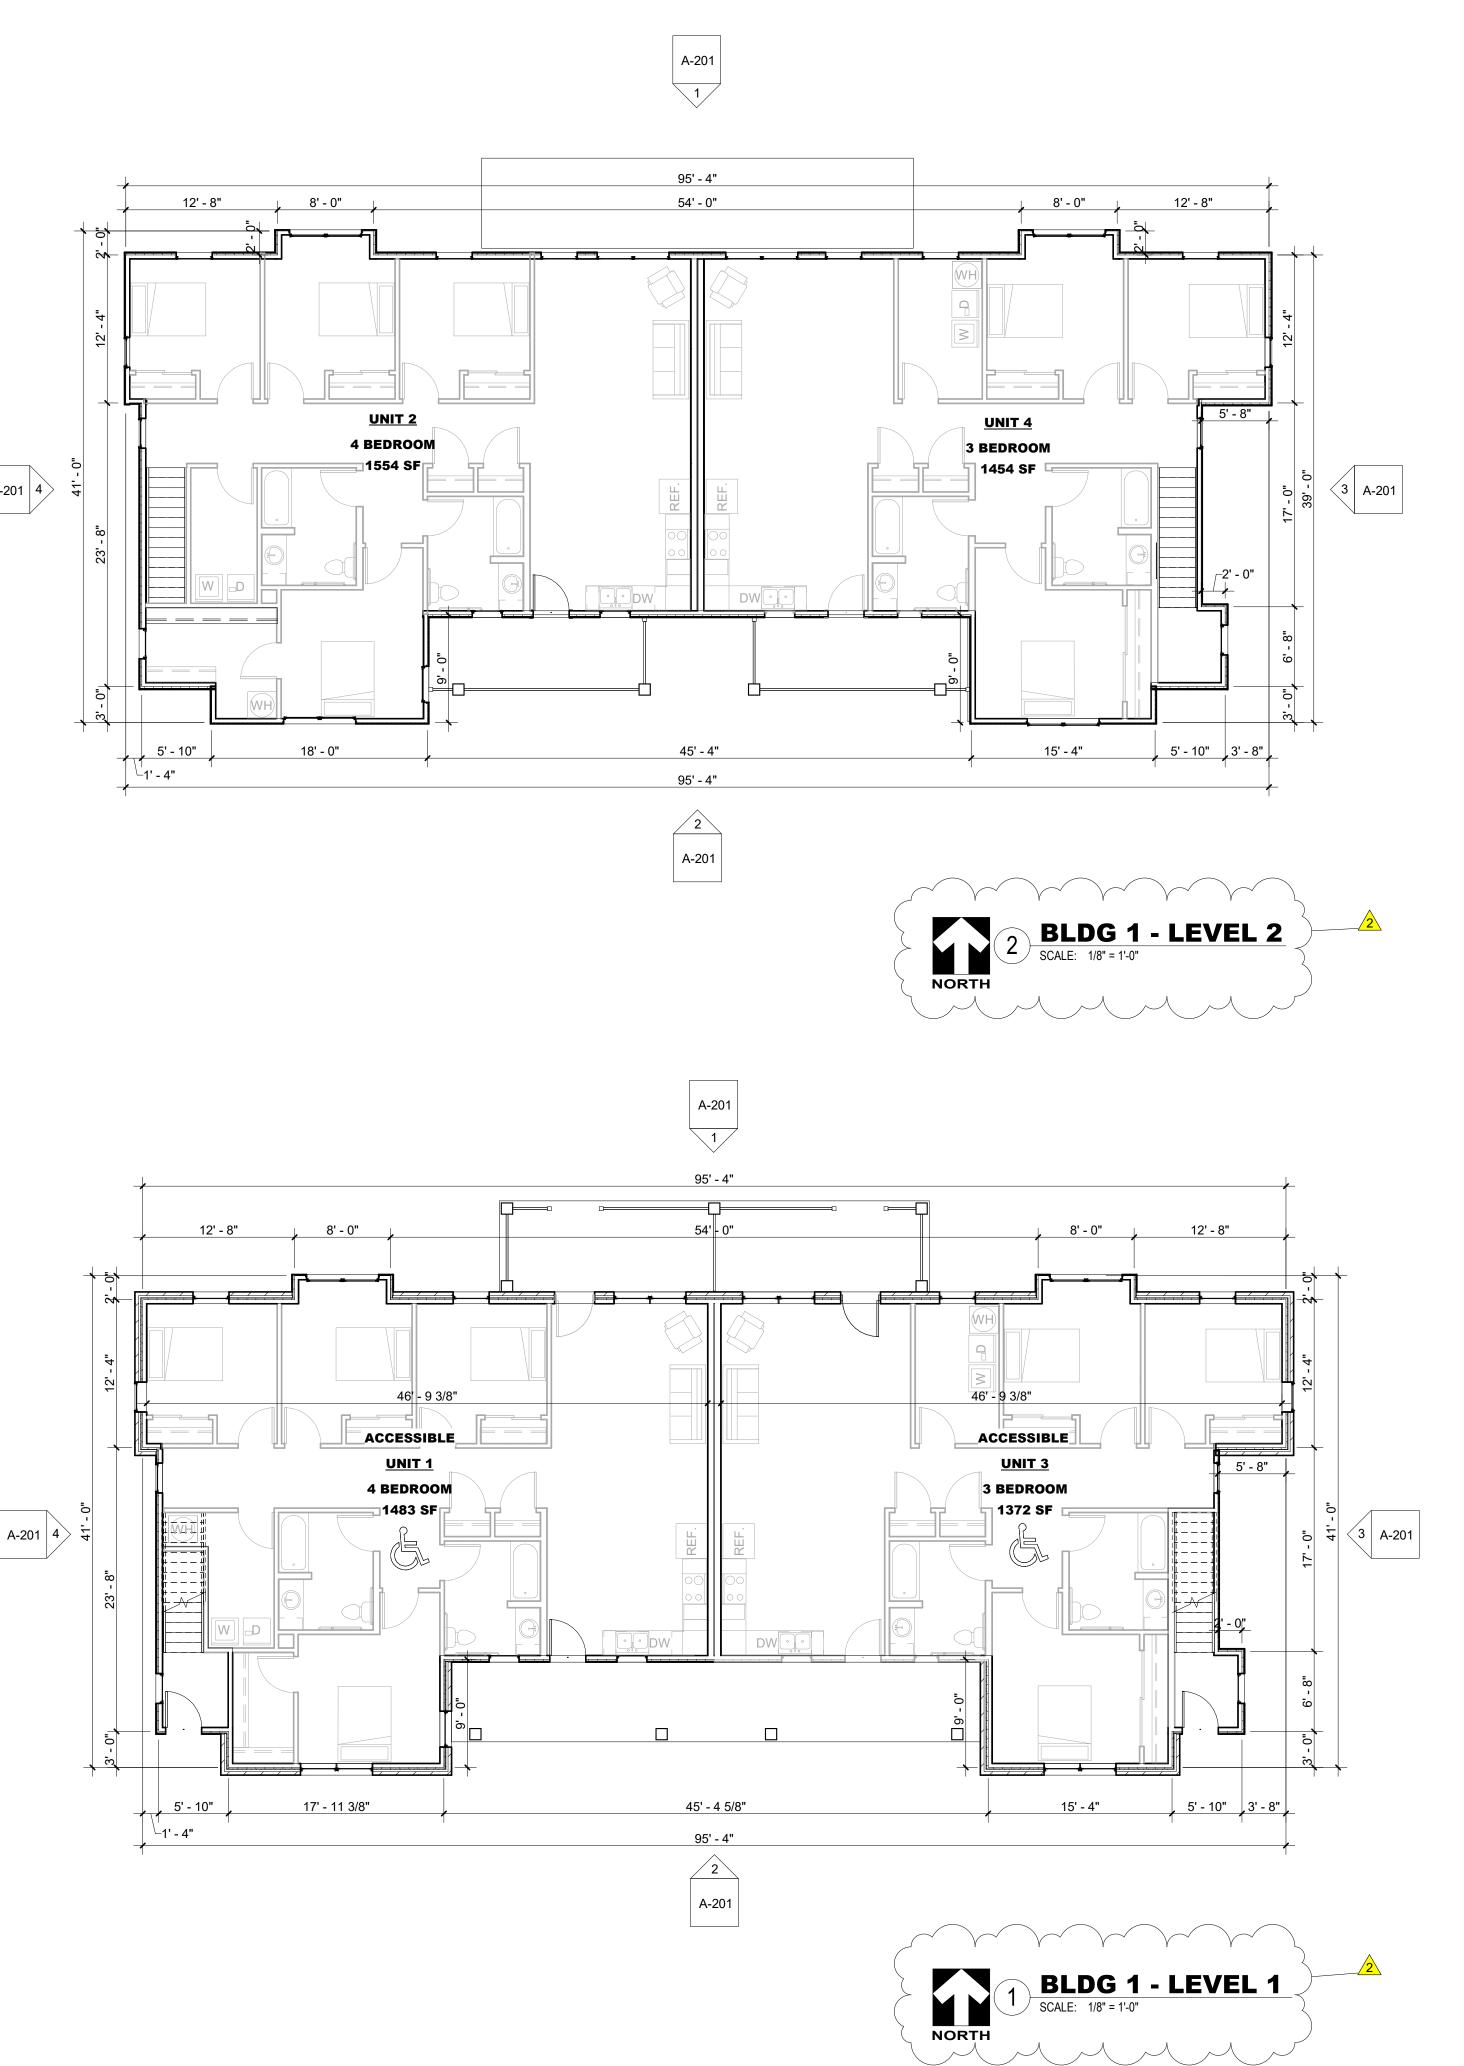
SITE PLAN

G-102

Sheet No.

Sheet Title





GENERAL FLOOR PLAN NOTES

1. REFER TO ADDITIONAL NOTES AND REQUIREMENTS ON ALL OTHER DOCUMENTS AND OTHER DISCIPLINES DOCUMENTS.

2. ALL SITE INFO, FURNITURE, FIXTURES AND EQUIPMENT SHOWN SHOULD BE CONSIDERED CONCEPTUAL AND MAY HAVE BE PROVIDED FOR COORDINATION PURPOSES ONLY. REFER TO CIVIL, FIRE SUPPRESSION, PLUMBING, MECHANICAL, ELECTRICAL, COMMUNICATIONS, ELECTRONIC SAFETY & SECURITY DOCUMENTS &/OR CONSULTANTS FOR SPECIFIC DESIGN INFORMATION & REQUIREMENTS.

3. DIMENSIONS ARE TO FACE OF FINISH MATERIAL OR CENTER OF STRUCTURE UNLESS OTHERWISE SPECIFIED.

4. ALL CONDUITS, PIPES, WIRING, ROUGH-IN, ETC. SHOULD BE HELD AS TIGHT AS POSSIBLE TO THE ROOF OR FLOOR DECK OR SHOULD BE KEPT WITHIN INTERIOR WALL CAVITIES. NOTHING SHALL BE BELOW THE BOTTOM EDGE OF MAIN BUILDING FRAMES, NOTHING SHALL BE EXPOSED IN FINISHED SPACES, NOTHING SHALL PREVENT A SMOOTH CONTINUOUS FINISHED WALL OR CEILING AS NOTED ON THE DRAWINGS AND NO PLUMBING RAN IN EXTERIOR WALLS UNLESS PRIOR APPROVAL IS GRANTED BY THE ARCHITECT OR OWNER. PLACEMENT COORDINATION BETWEEN TRADES IS REQUIRED.

5. INSTALL VERTICAL EXPANSION JOINT MINIMAL AT COLUMN/GRID LINES AND AT THE HEAD OF DOOR JAMBS/OPENINGS OR AS OTHERWISE NOTED OR WHERE REQUIRED PER STANDARD MATERIAL PRACTICE TO REDUCE STRESS CRACKING. NO CONTROL JOINT/EXPANSION JOINT IN LOAD BEARING AREAS, STAY AWAY 2'-6" MIN.

6. CAULK & SEAL ALL CONTROL-EXPANSION, SAWCUT JOINTS AT ALL INTERIOR & EXTERIOR MASONRY & CONCRETE.

7. PROVIDE LOWER LEVEL AND/OR UNDERFLOOR DRAINAGE SYSTEM TO REDUCE HYDROSTATIC UPLIFT AND PROTECT AGAINST MOISTURE SEEPAGE. PROVIDE FOUNDATION WALL DRAINAGE SYSTEM TO REDUCE LATERAL PRESSURES AND PROTECT AGAINST MOISTURE SEEPAGE. BOTH SYSTEMS SHALL OUTLET TO APPROPRIATE RELIEF.

8. PROVIDE POSITIVE DRAINAGE OF SURFACE WATER AWAY FROM BUILDING WITHOUT PONDING OF WATER ADJACENT TO BUILDING OR ON PAVEMENTS.

2023 9% IFA LIHTC FLOOR & UNIT PLAN REQUIREMENTS

PART A – APPLICATION REQUIREMENTS SECTION 6. SCORING CRITERIA

6.3 Market Appeal (5 points maximum)

A. Ceiling Fans: 1 point

The Project will provide ceiling fan/light combination units, minimum 2 per 1 or more bedroom Units and 1 per studio Unit. B. Trash and Recycling: 1 point

Trash chutes or a dedicated onsite recycling area. C. Laundry:

Acquisition/Rehab projects without in-unit laundry that provide tenants unlimited access to the community laundry facility at no charge, or Acquisition/Rehab projects that add in-unit washers and dryers to all units during the rehabilitation. Free Resident/Community Laundry 3 points

In-Unit washers and dryers (added to Acquisition/Rehab) 4 points

D. Exterior Materials: 5 points Minimum of 30% of the gross exterior (excluding window and door areas), of 4" nominal brick, 4" nominal stone, stucco over masonry, architectural CMU block, or pre-cast concrete wall panels. The remaining 70% shall be constructed of 100% fiber cement board siding or engineered wood siding with quality standards similar to Smartside. The buildings' soffit and fascia shall be prefinished aluminum, fiber cement board, or engineered wood siding with quality standards similar to Smartside. Soffits shall be vented.

PART C – CONSTRUCTION REQUIREMENTS SECTION 14. PRIOR TO INITIATION OF CONSTRUCTION

<u>14.6. Minimum Development Characteristics</u>

A. General

1. Construction Warranty. Provide an enforceable minimum 1 year blanket construction warranty stipulating that the general contractor is responsible to do or have done any and all required warranty repair work, including consequential damages, at its own expense.

- 2. No Smoking Policy. Implement and enforce a "no smoking" policy in all Units and common areas, not including public areas of the exterior grounds.
- 3. **Playground**. For family Projects only, an outdoor area provided for children to play in containing 5 to 7 commercial-grade play components (an element intended to generate specific opportunities for play, socialization, or learning) that does not include wood. At least 2 must be elevated. Swings, spring riders, water tables, playhouses, slides, and climbers are acceptable; ramps, transfer systems, steps, decks, and roofs are not. IFA may approve a sport court. The playground must comply with the requirements of the Department of Justice 2010 ADA Standards for Accessible Design. Does not apply to Scattered Site Projects.
- 4. Sidewalks. Concrete sidewalks providing access to a city public way from each entrance door. 5. Trash Enclosures. Screened trash removal areas.
- 6. Internet Access. High-speed internet wiring for broadband, wireless, or digital subscriber line for all Units.
- 7. Radon System. A passive radon system, including a drain tile loop below the building slab along with vertical vent pipes and junction boxes for new construction. Acquisition/Rehab Projects shall have a radon test, and a passive radon system is required, or an active system if the radon test exceeds permissible thresholds. Refer to Appendix F – "Radon Control Methods" in the 2012 International Residential Code.

8. Video Security System. The security system shall record activity at the site as follows: Parts of the site to be covered include parking areas and all levels of stairways. Cameras in corridors shall be placed in such a way that all unit entrances are covered The recordings shall be maintained for a minimum of 30 days. To be eligible for points, single family or each building in Scattered Site Projects are required to have the Video Security System.

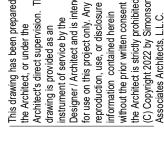
D. Energy Requirements

Heating and Air Conditioning. All Units shall be heated and air conditioned. Air conditioning equipment shall be at least 13 SEER (14.5 SEER and 8.50 HSPF for electric heat pumps) and use R-410a refrigerant that is charged according to manufacturer specifications. Thru-wall A/C units, when used in conjunction with fluid based radiant heat systems, shall be at least 9.8 EER or 9.7 CEER, otherwise they shall be 10.7 EER or 10.6 CEER. Heating equipment shall be at least 95 AFUE for furnaces and 90 AFUE for boilers. Window units are not allowed. Electric resistance heating is not allowed as the primary heating source for new construction or adaptive reuse and must be approved at time of application if proposed for an Acquisition/Rehab or rehab project. AC sleeves shall be provided with a tight-fitting, insulated cover for thru wall AC units. Winter covers shall be provided for each AC unit. IFA may approve existing projects with electric resistance heating prior to Application submittal. 2. Water Heaters.

a. In-unit water heaters that have a minimum energy factor (EF) of 0.61 for tank-type gas, 0.93 for tank-type electric, or 0.96 for tankless water heaters.

b. Central water heaters (serving entire building) – with a 90% Thermal Efficiency rating or minimum 95% efficient thermal water storage tanks coupled to a better than 90 AFUE boiler.

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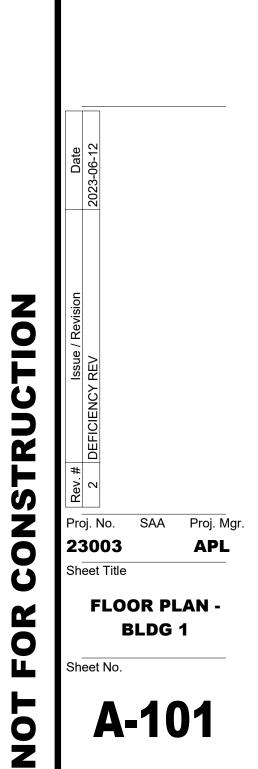
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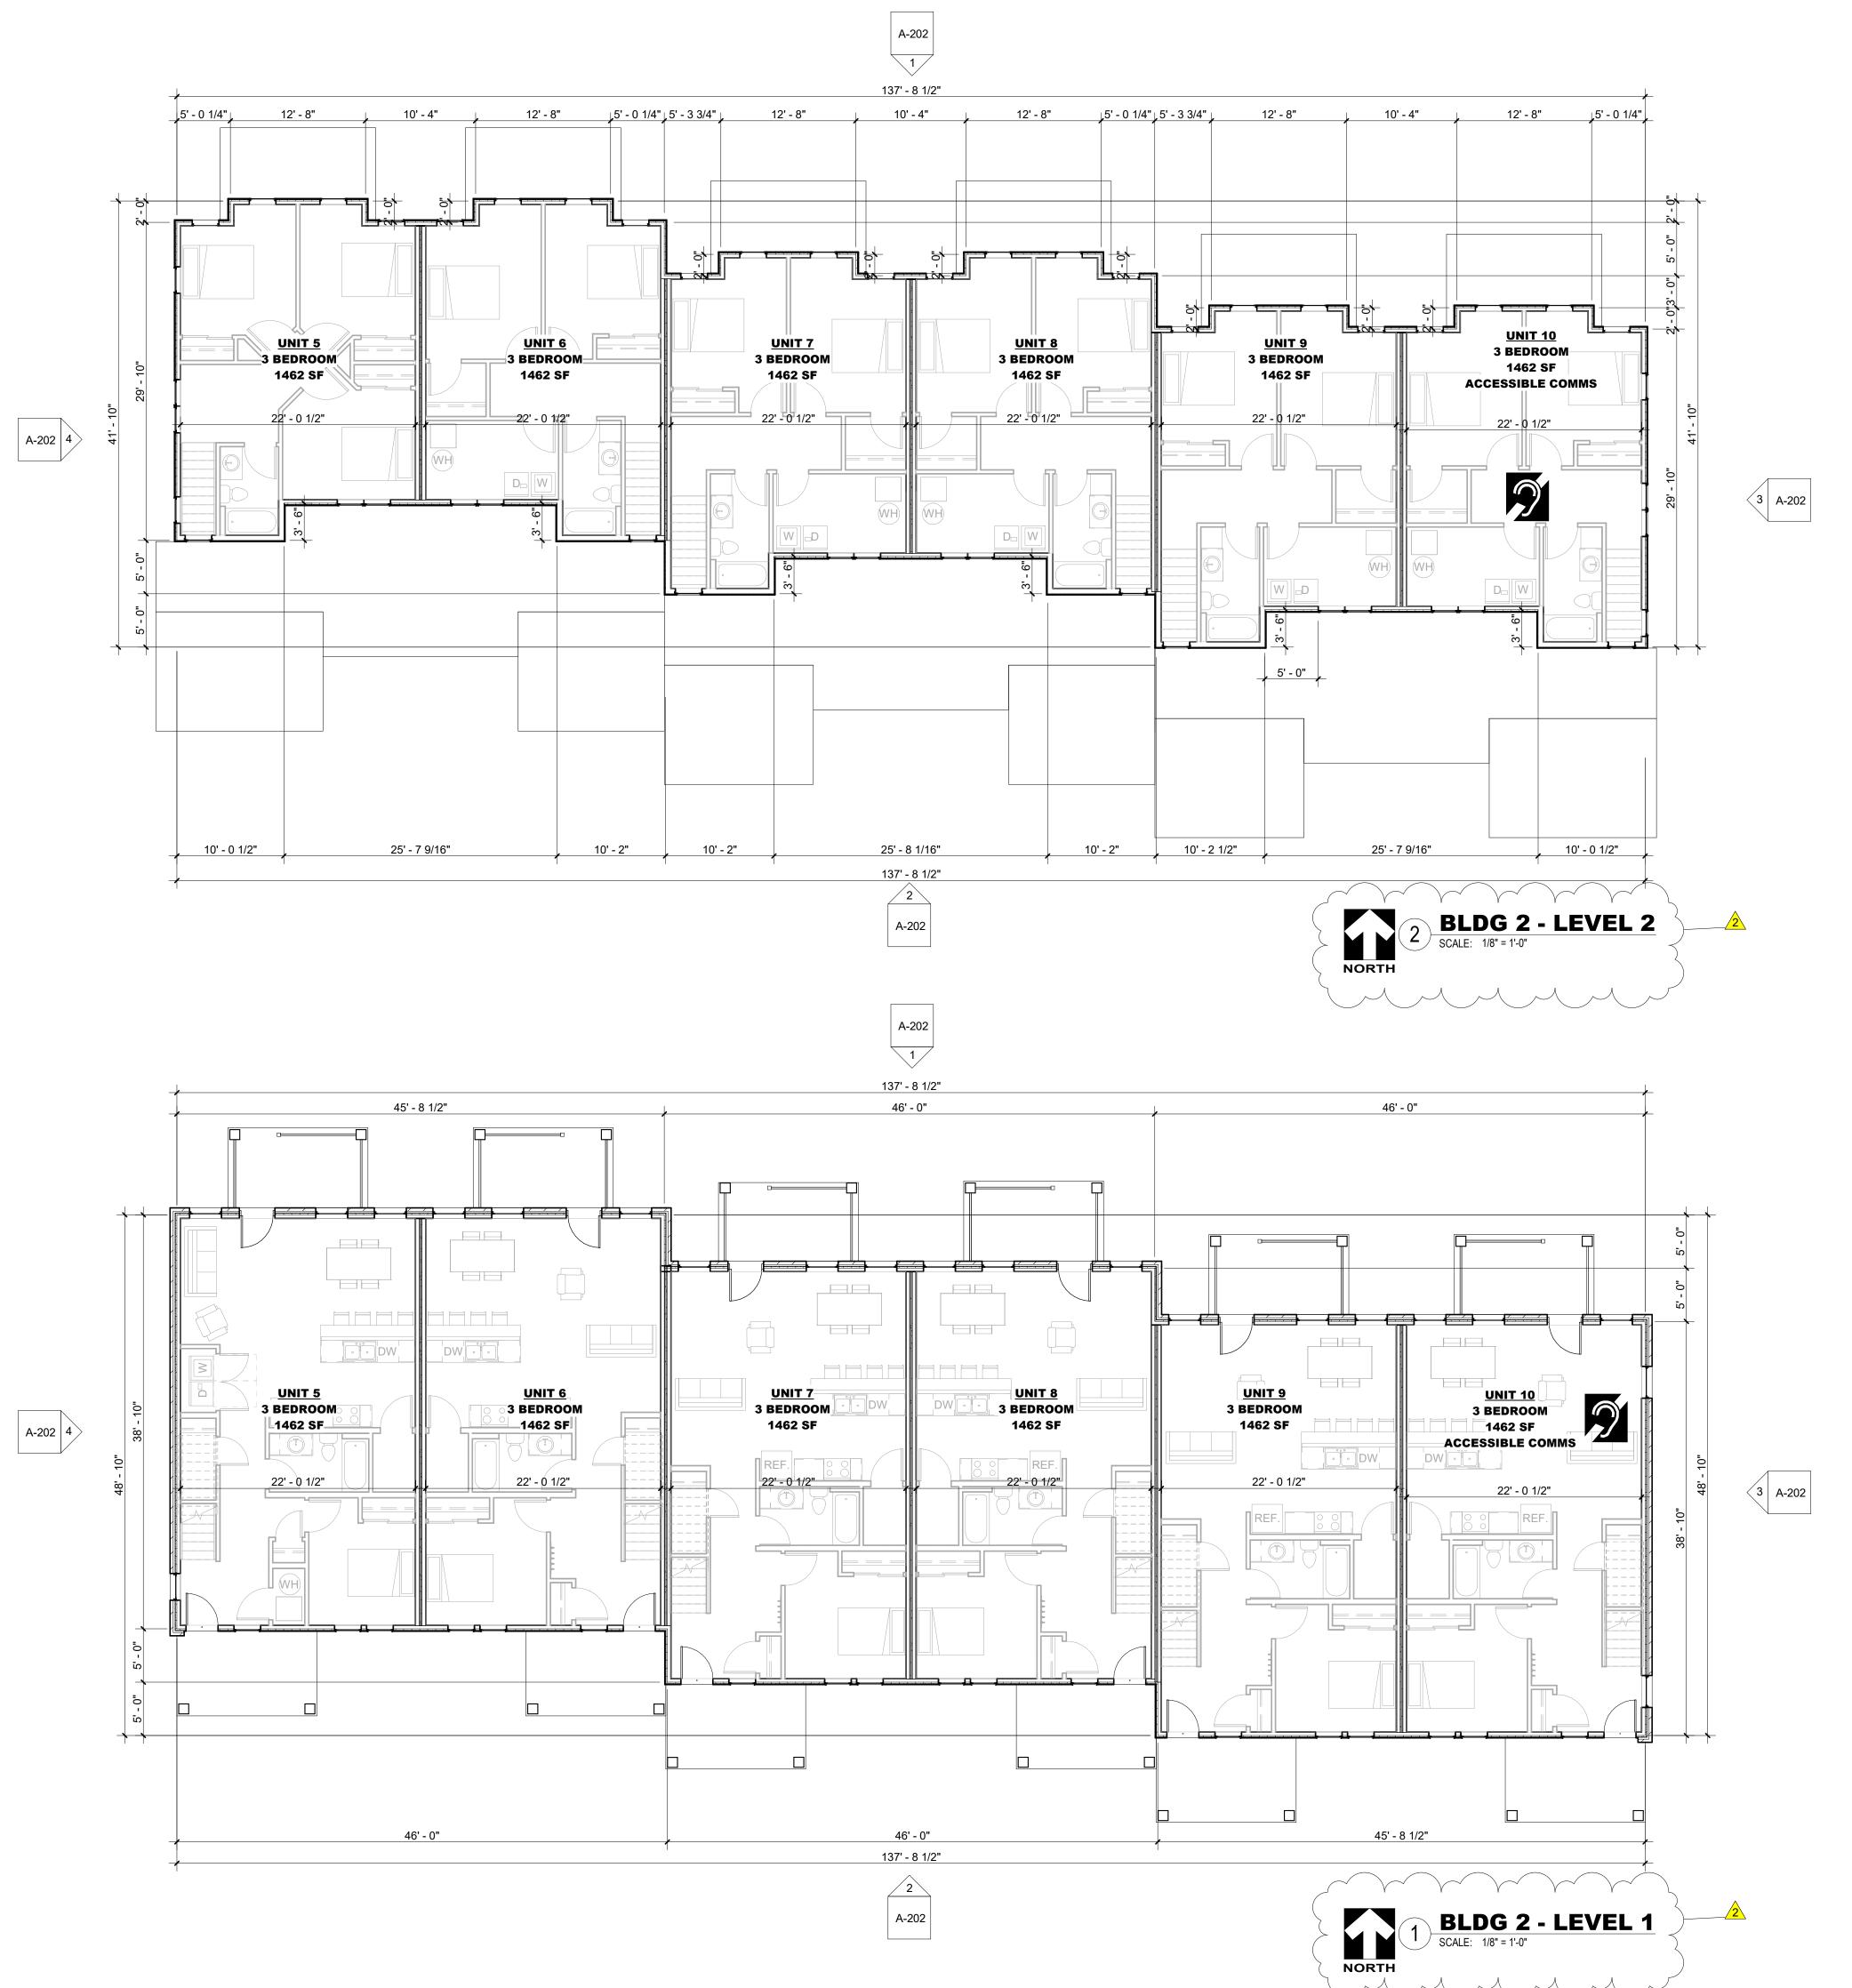
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A. General

GENERAL FLOOR PLAN NOTES

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Acquisition/Rehab projects without in-unit laundry that provide tenants unlimited access to the community laundry facility at no charge, or Acquisition/Rehab projects that add in-unit washers and dryers to all units during the rehabilitation. Free Resident/Community Laundry 3 points

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PART C – CONSTRUCTION REQUIREMENTS SECTION 14. PRIOR TO INITIATION OF CONSTRUCTION

<u>14.6. Minimum Development Characteristics</u>

1. Construction Warranty. Provide an enforceable minimum 1 year blanket construction warranty stipulating that the general contractor is responsible to do or have done any and all required warranty repair work, including consequential damages, at its own expense.

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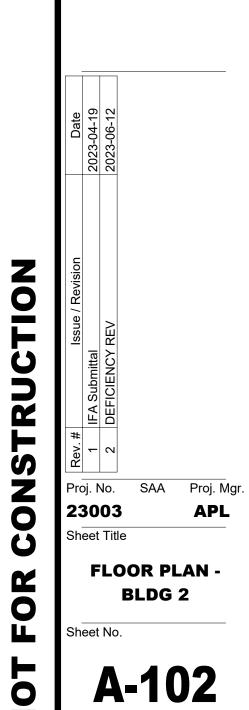




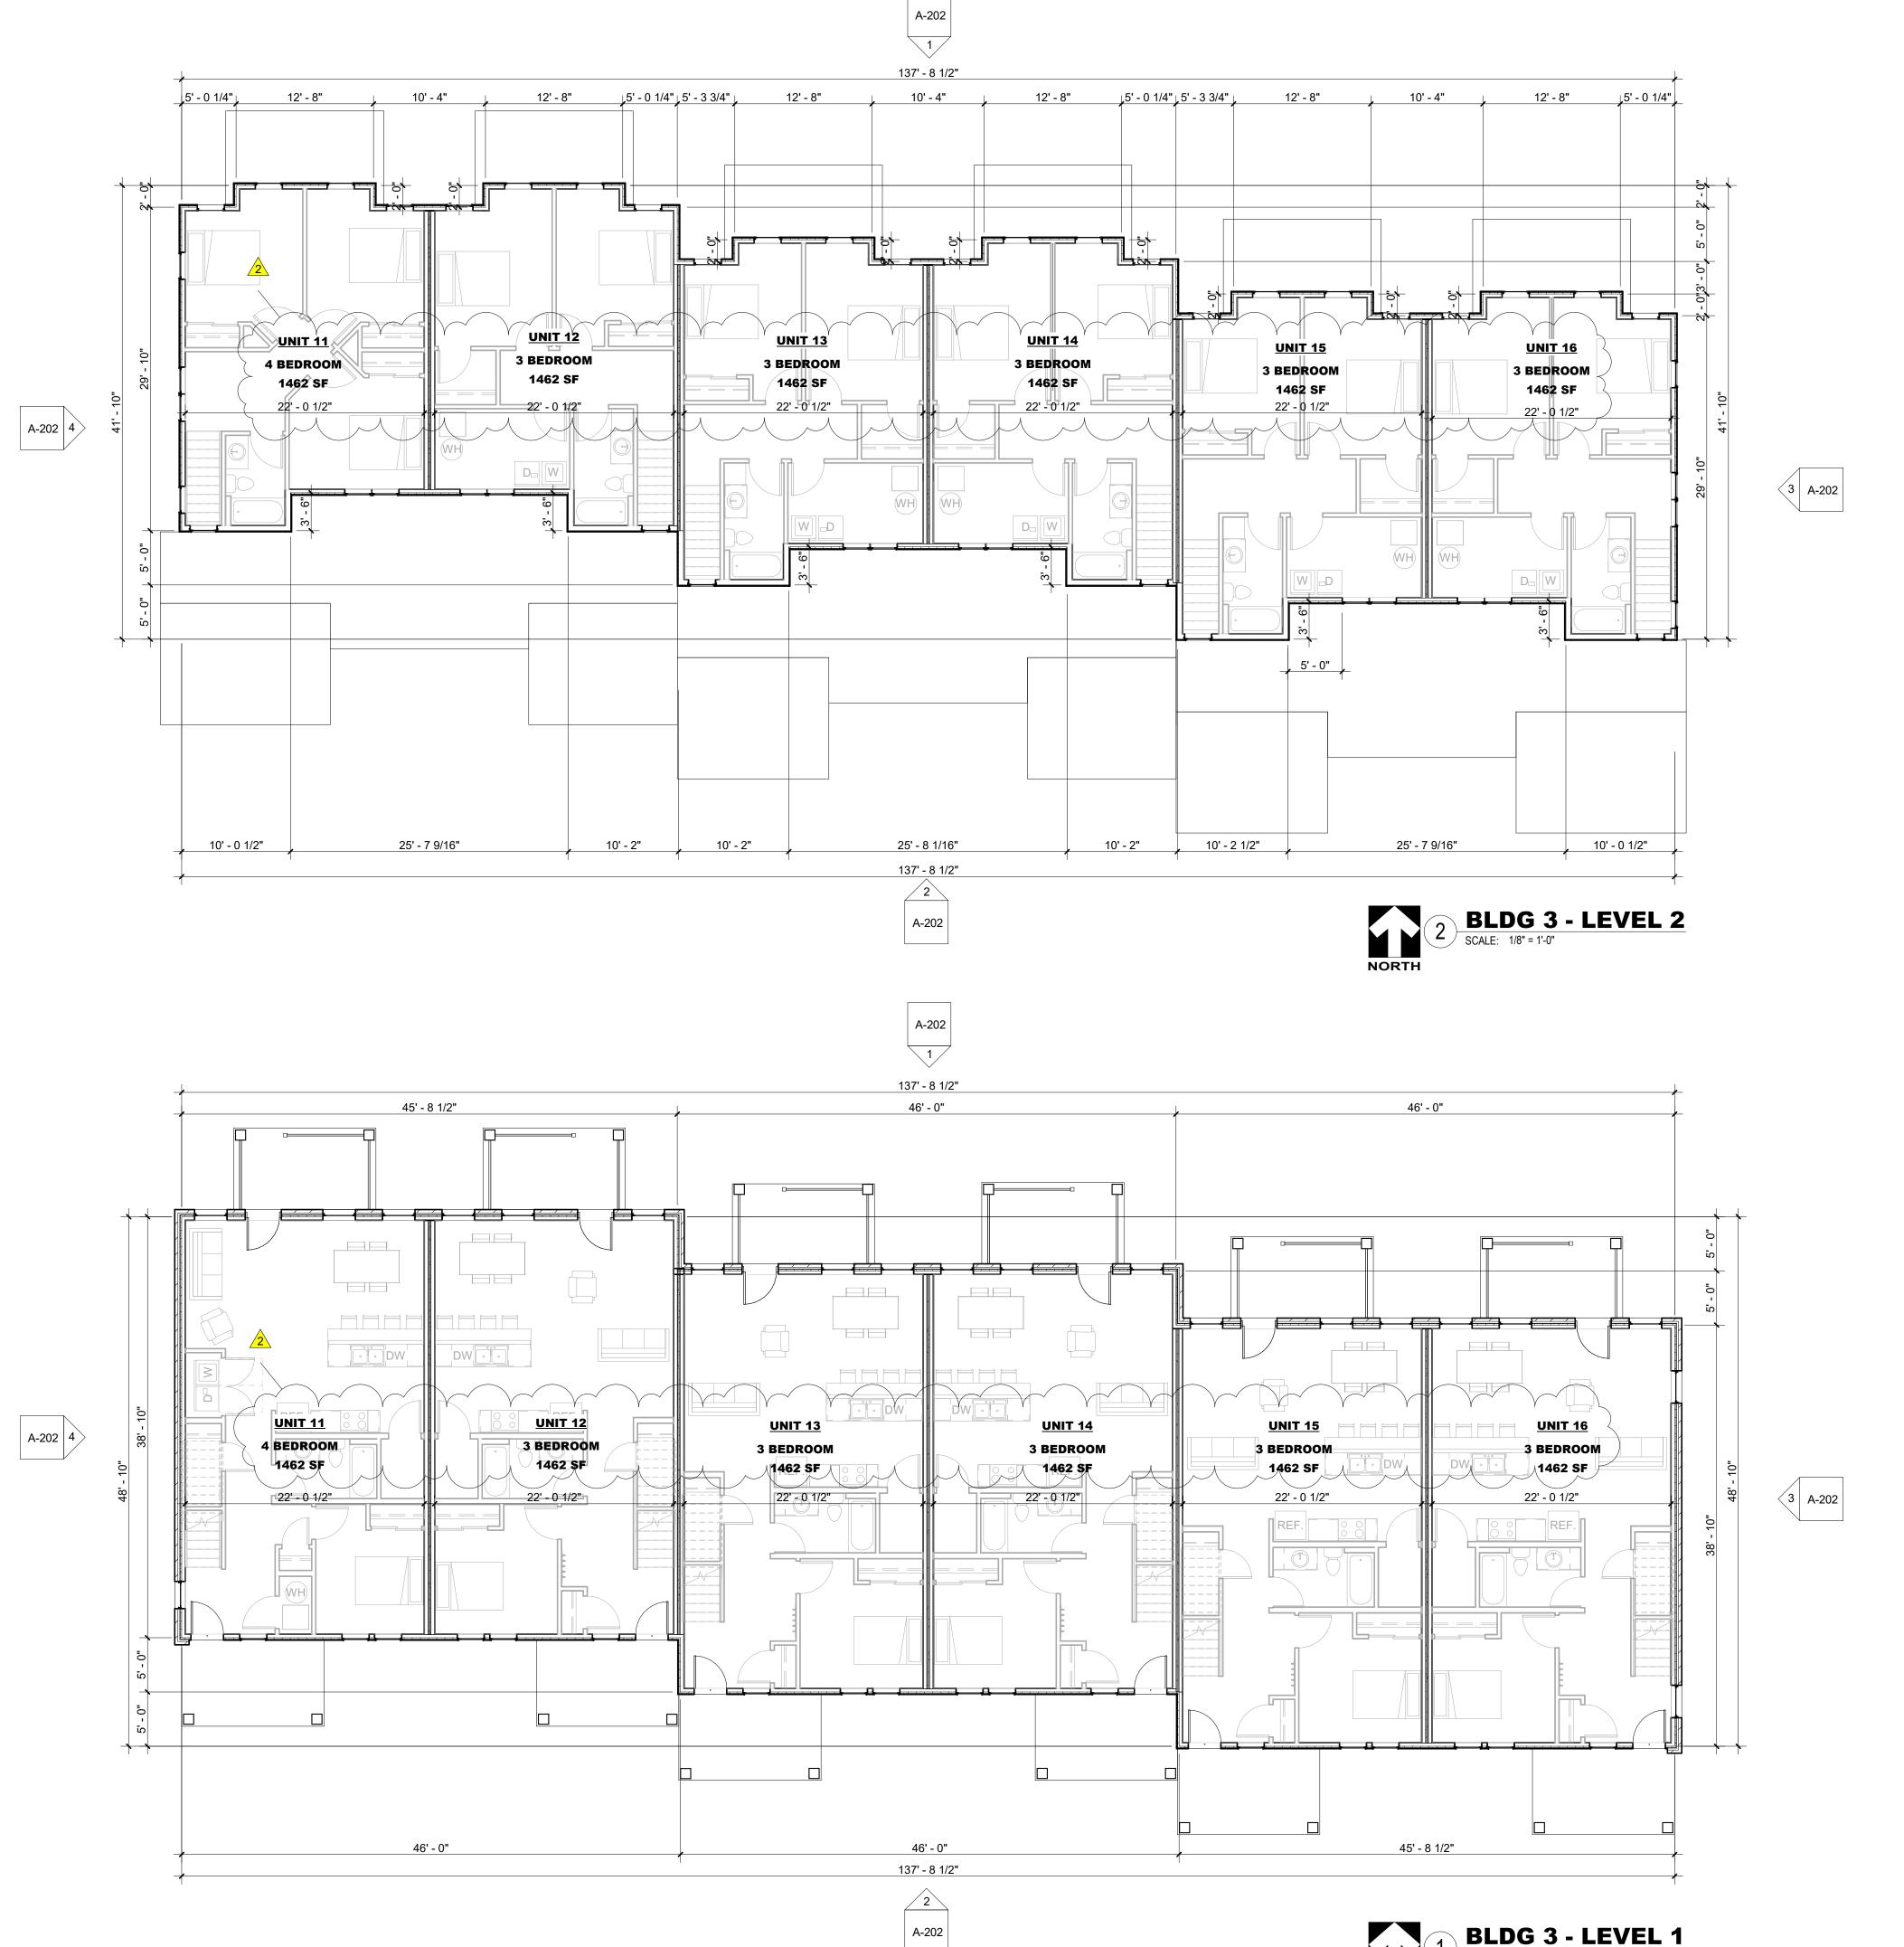


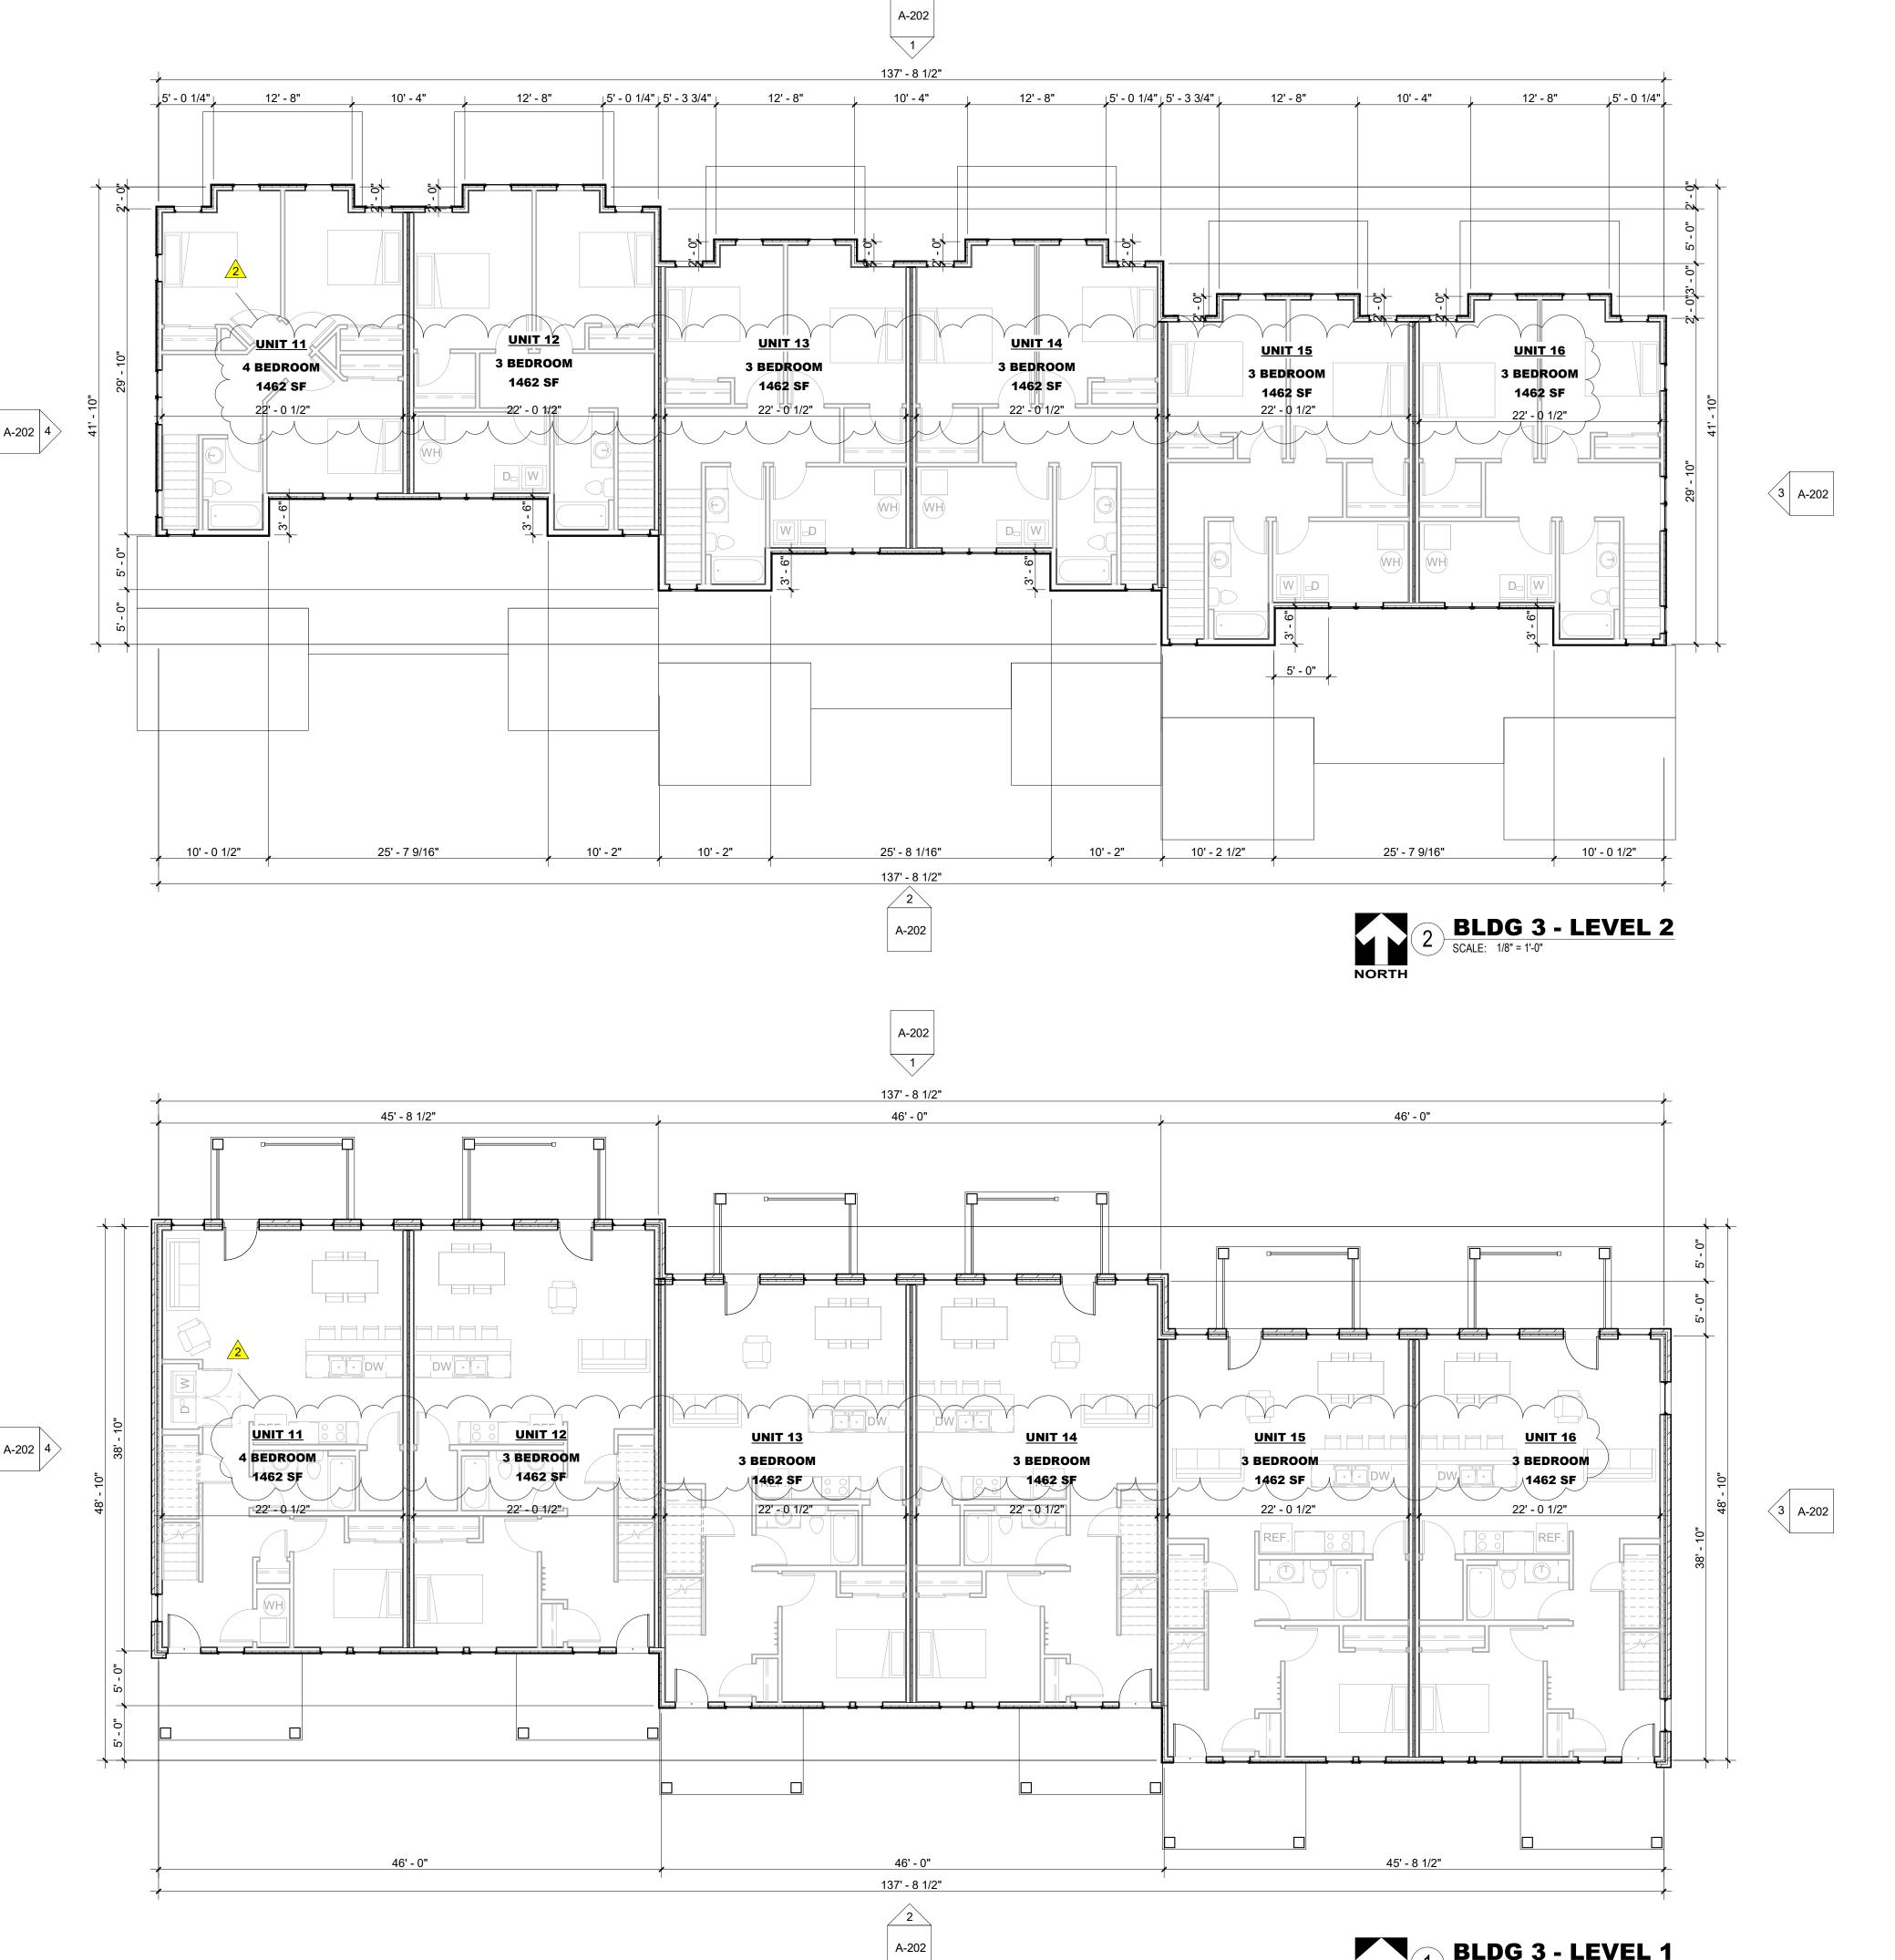


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SCALE: 1/8" = 1'-0"

GENERAL FLOOR PLAN NOTES

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6. CAULK & SEAL ALL CONTROL-EXPANSION, SAWCUT JOINTS AT ALL INTERIOR & EXTERIOR MASONRY & CONCRETE.

7. PROVIDE LOWER LEVEL AND/OR UNDERFLOOR DRAINAGE SYSTEM TO REDUCE HYDROSTATIC UPLIFT AND PROTECT AGAINST MOISTURE SEEPAGE. PROVIDE FOUNDATION WALL DRAINAGE SYSTEM TO REDUCE LATERAL PRESSURES AND PROTECT AGAINST MOISTURE SEEPAGE. BOTH SYSTEMS SHALL OUTLET TO APPROPRIATE RELIEF.

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2023 9% IFA LIHTC FLOOR & UNIT PLAN REQUIREMENTS

PART A – APPLICATION REQUIREMENTS SECTION 6. SCORING CRITERIA

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A. Ceiling Fans: 1 point

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In-Unit washers and dryers (added to Acquisition/Rehab) 4 points

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PART C – CONSTRUCTION REQUIREMENTS SECTION 14. PRIOR TO INITIATION OF CONSTRUCTION

<u>14.6. Minimum Development Characteristics</u>

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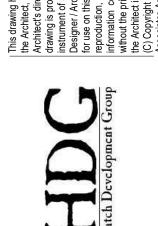
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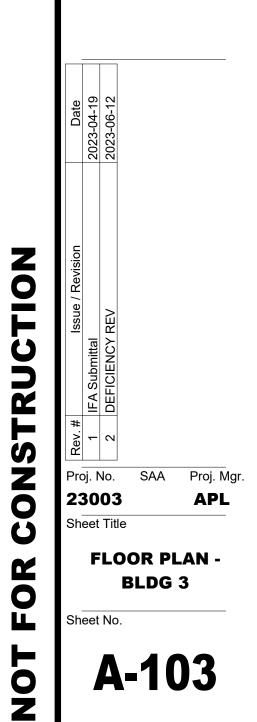


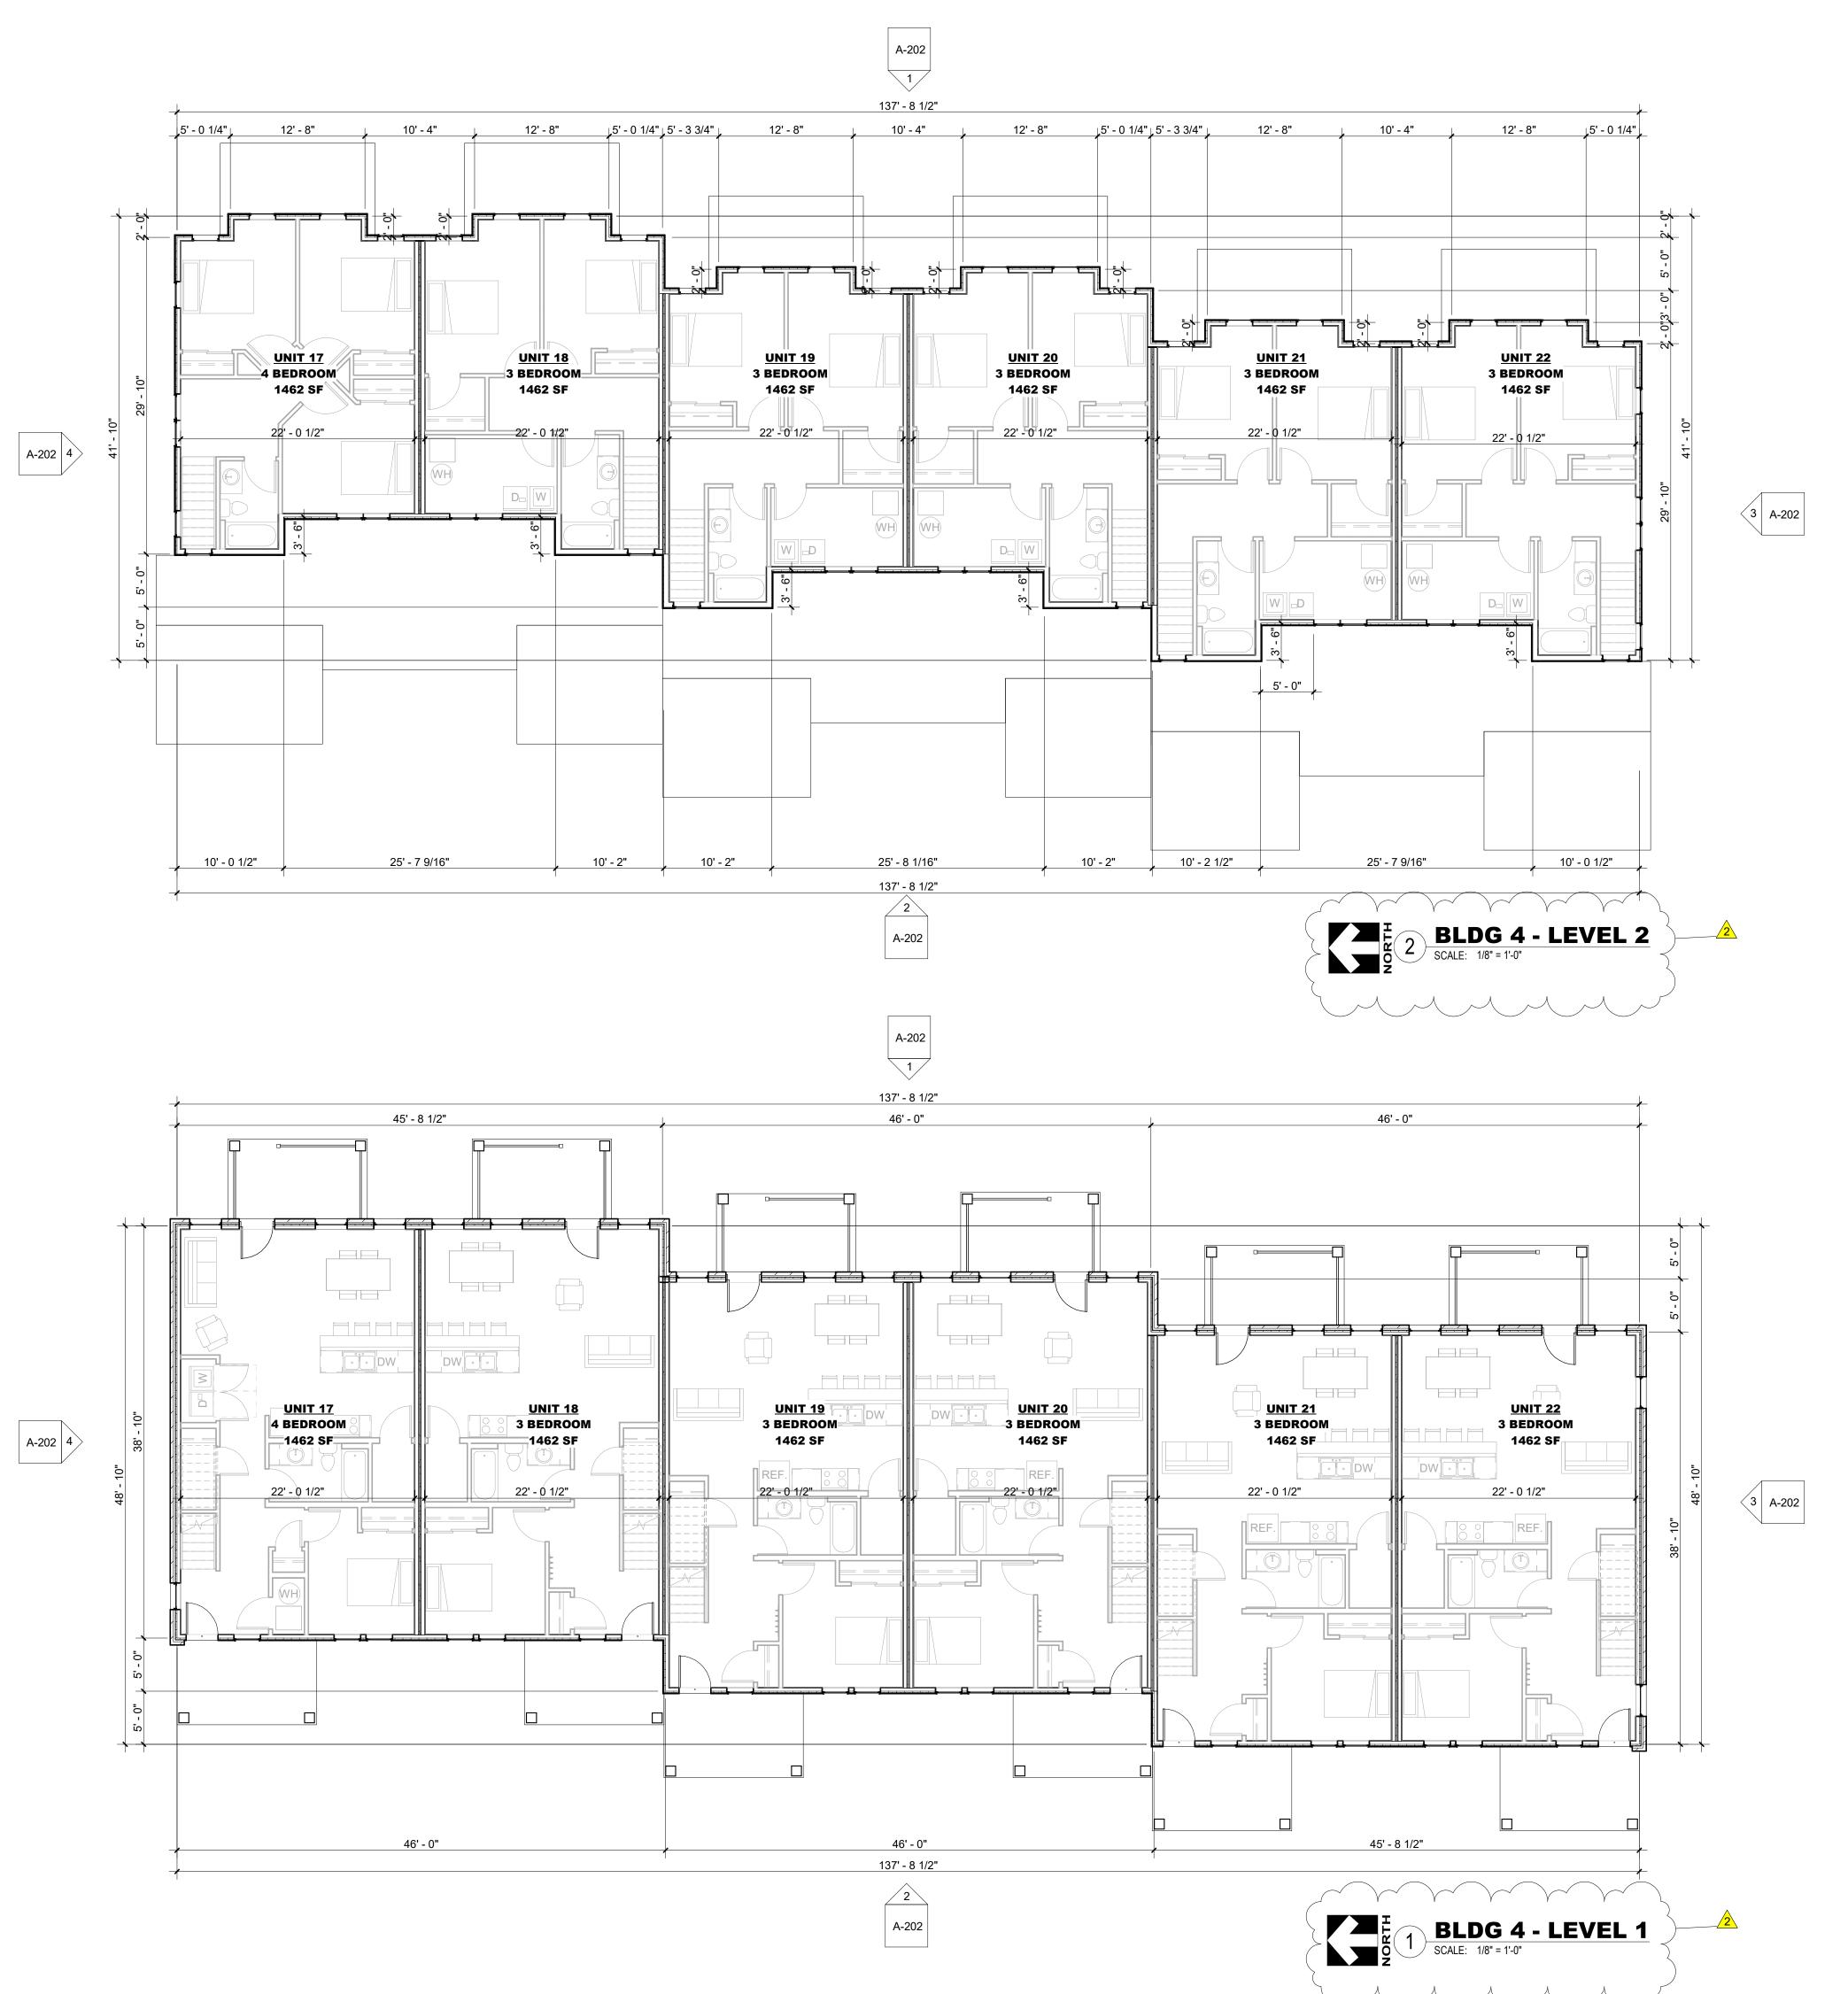


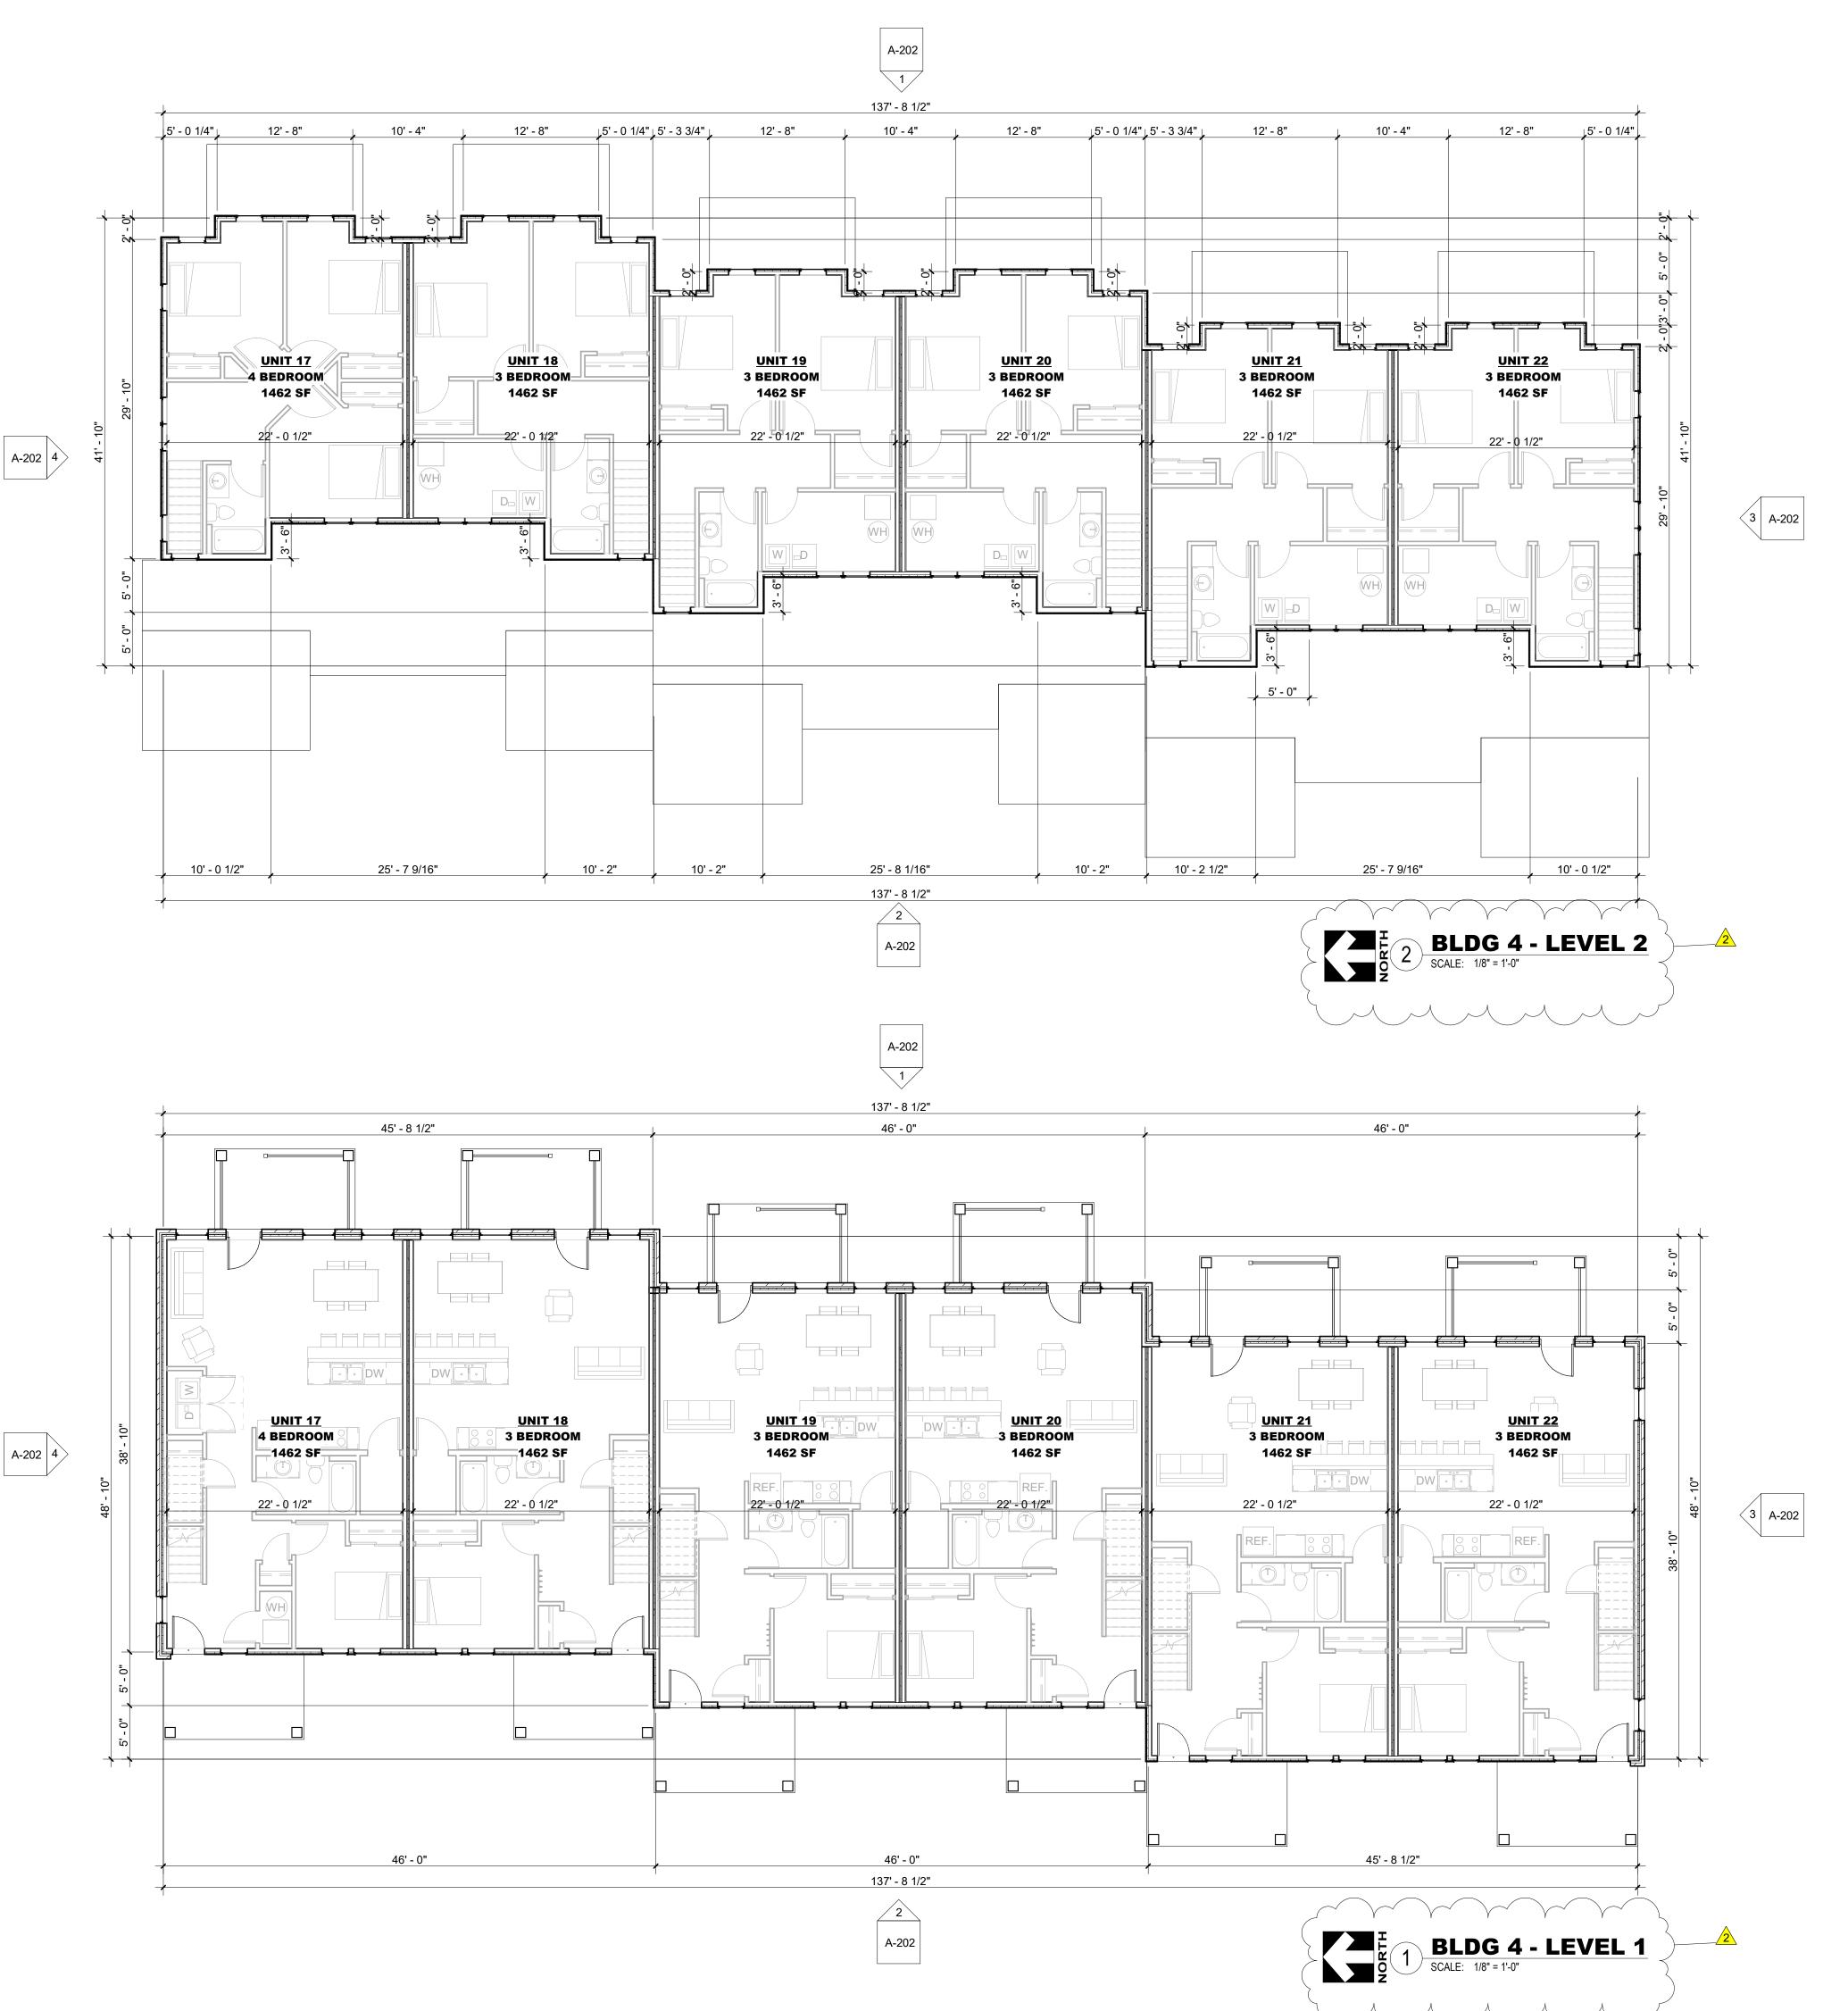




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<u>14.6. Minimum Development Characteristics</u>

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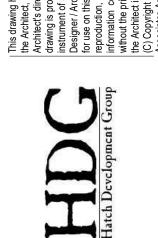
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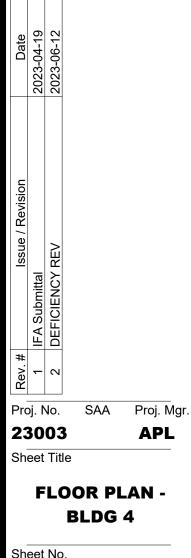
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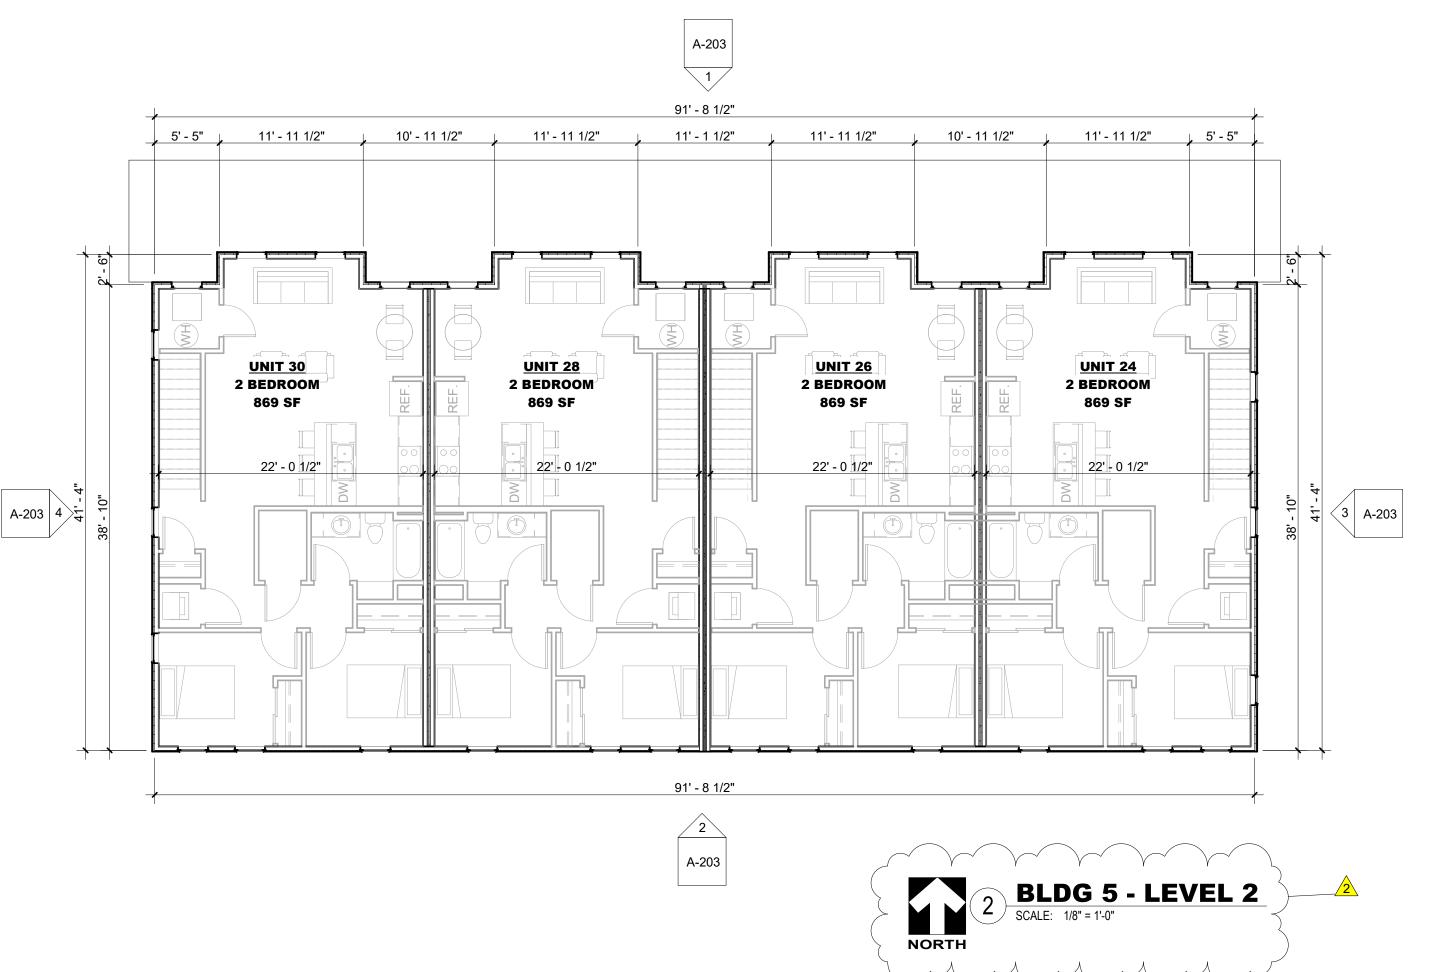


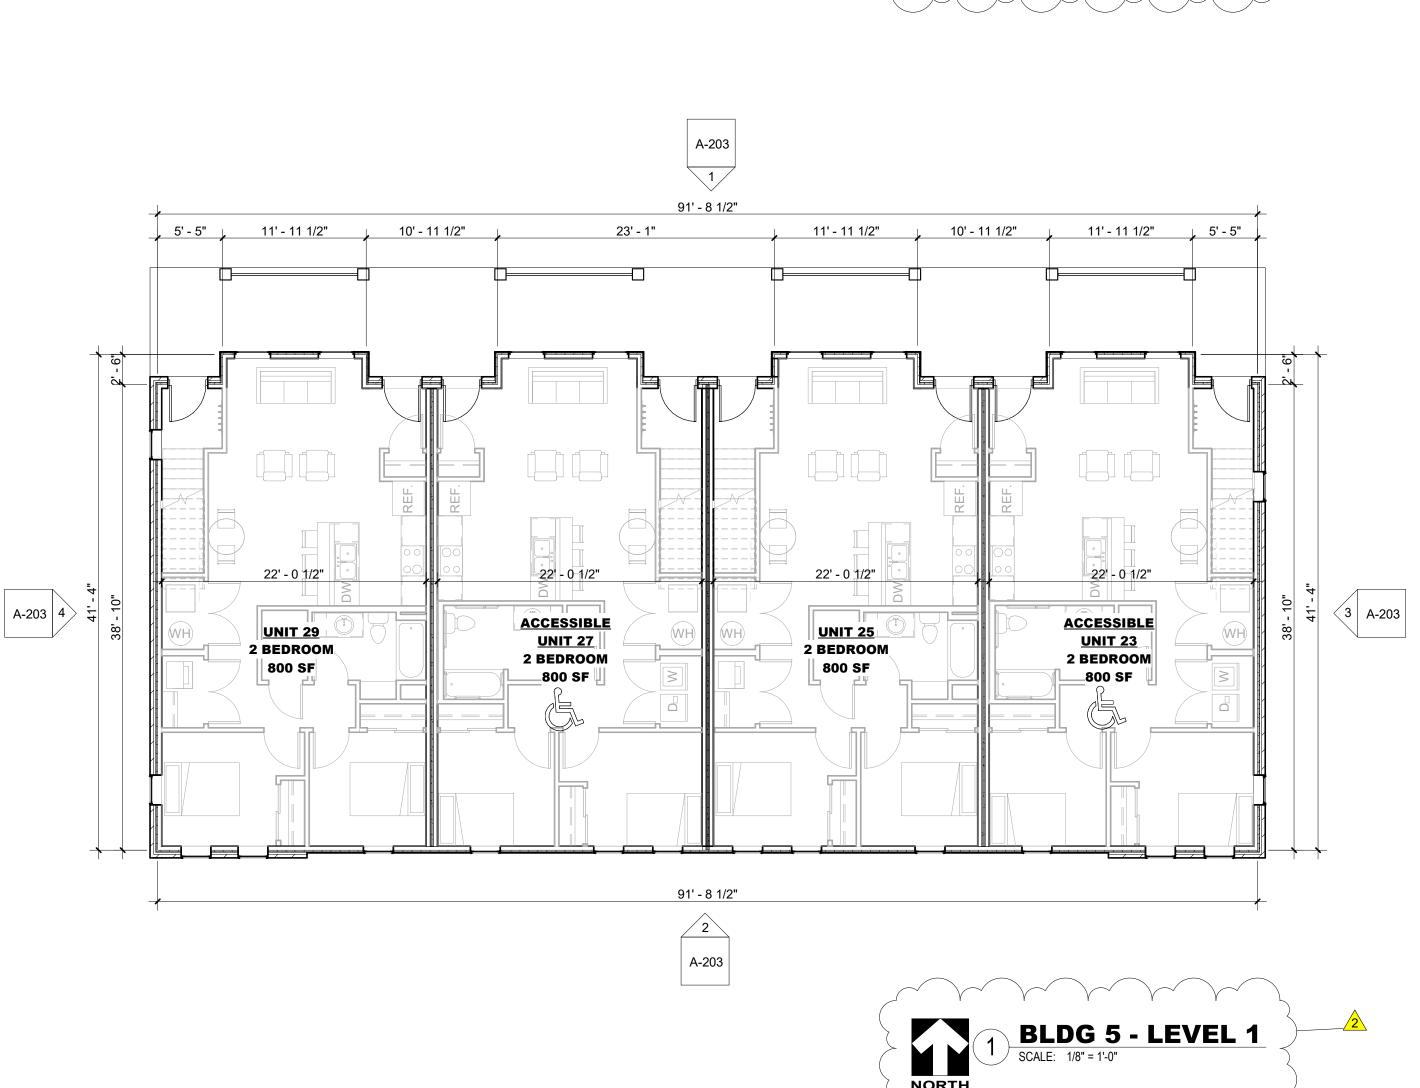
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2023 9% IFA LIHTC FLOOR & UNIT PLAN REQUIREMENTS

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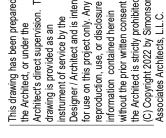
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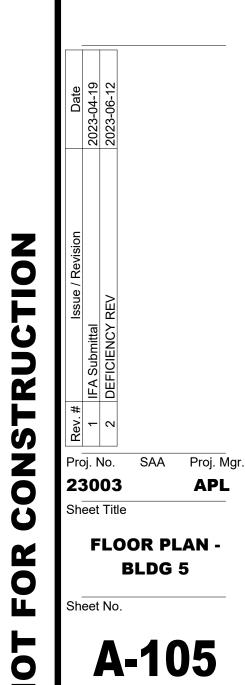
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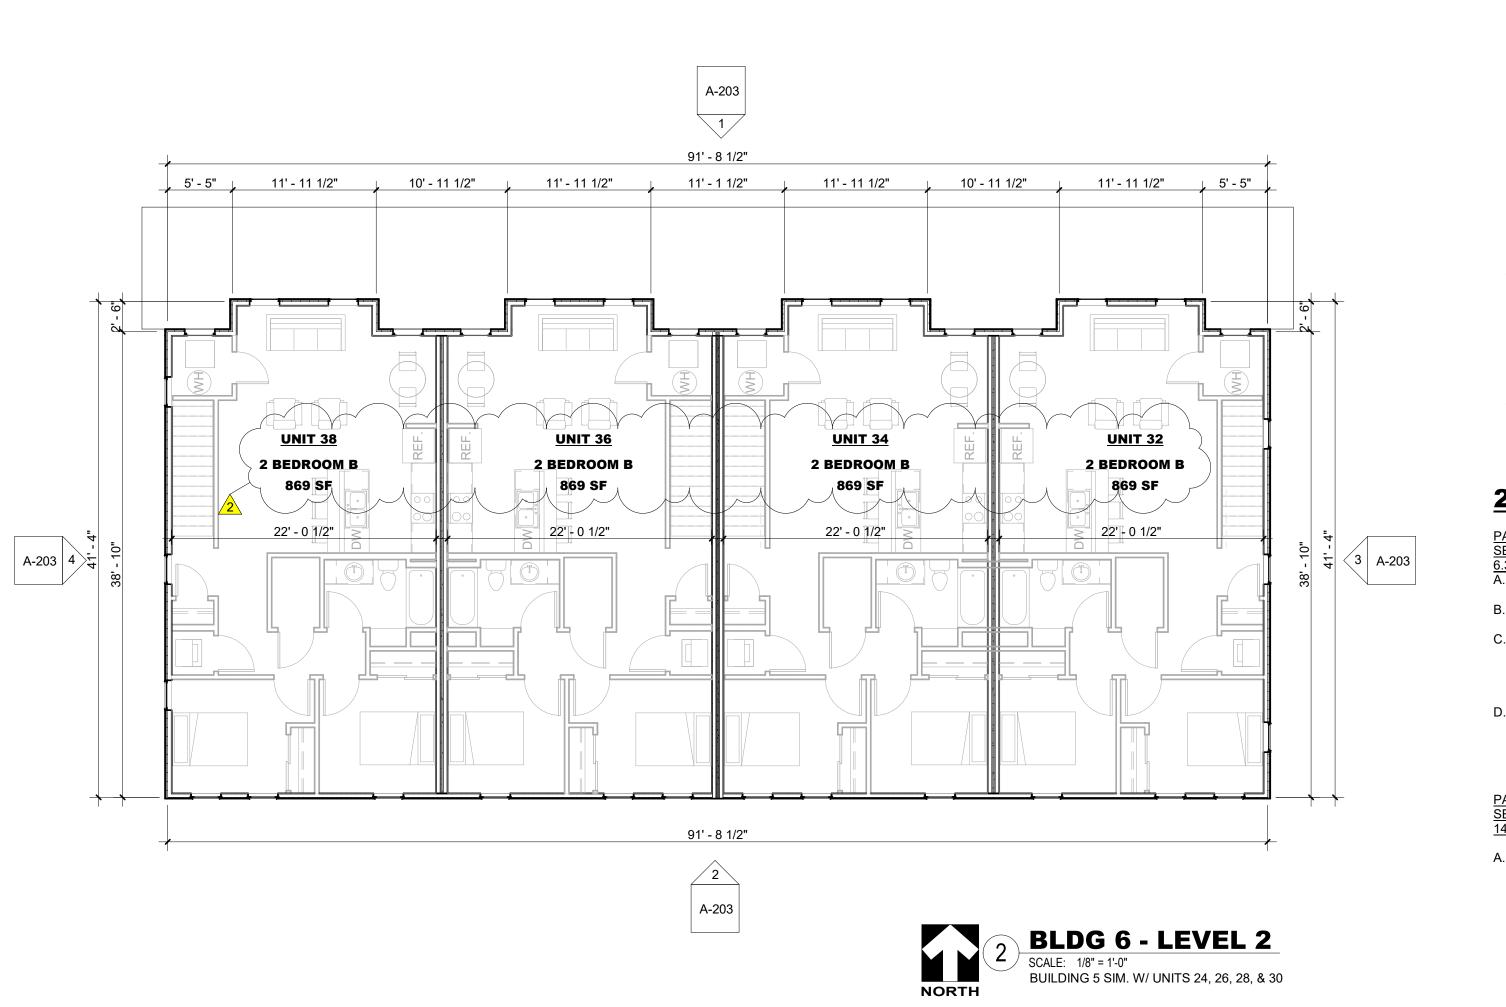
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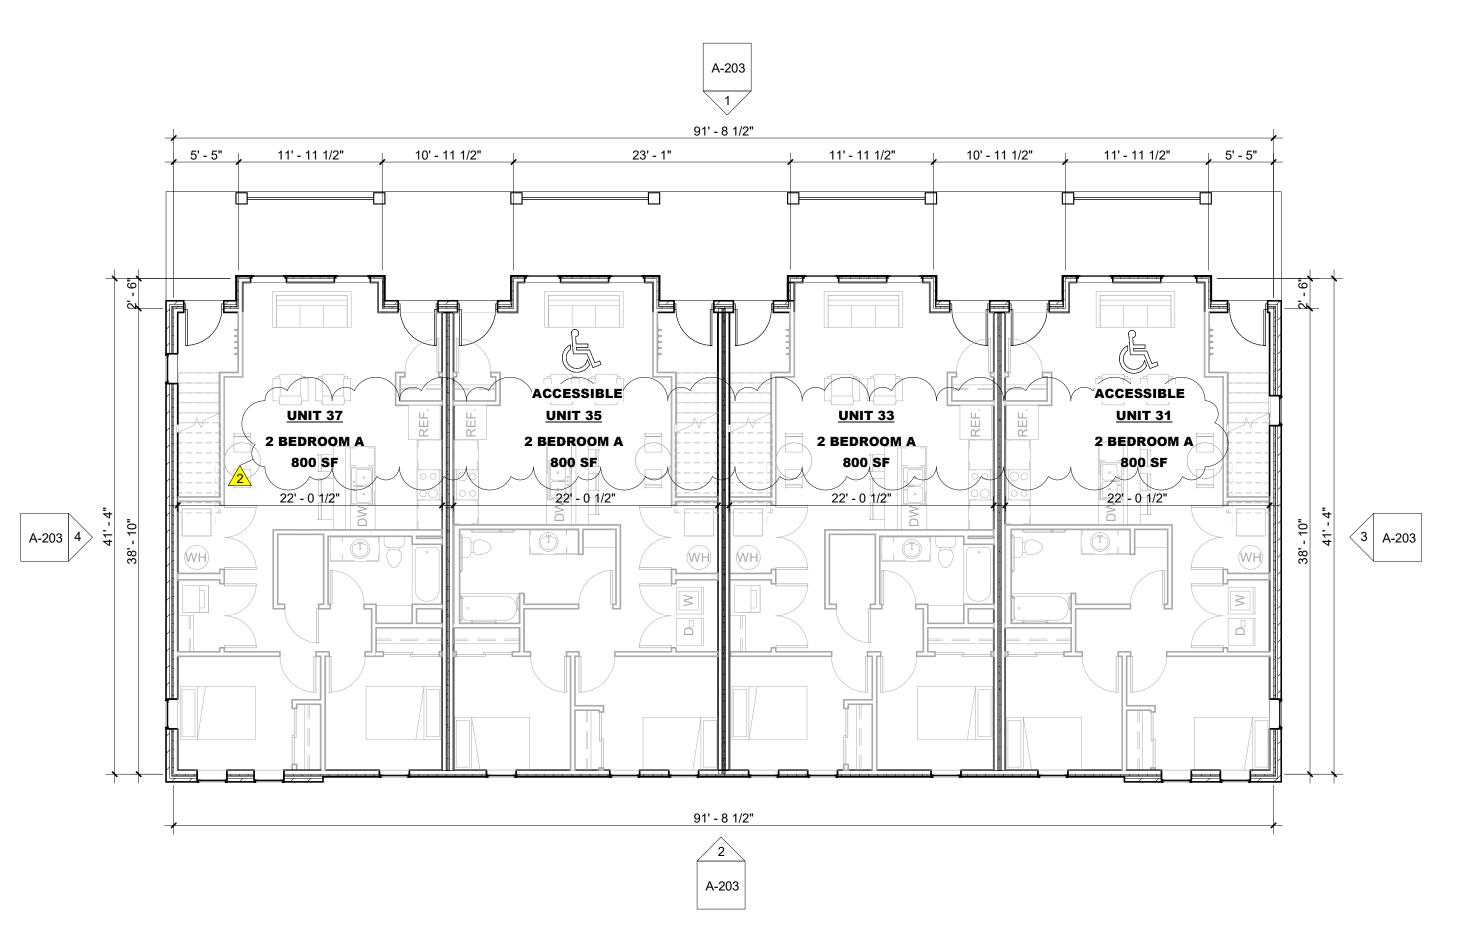
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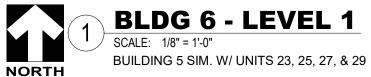


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D. Energy Requirements

Heating and Air Conditioning. All Units shall be heated and air conditioned. Air conditioning equipment shall be at least 13 SEER (14.5 SEER and 8.50 HSPF for electric heat pumps) and use R-410a refrigerant that is charged according to manufacturer specifications. Thru-wall A/C units, when used in conjunction with fluid based radiant heat systems, shall be at least 9.8 EER or 9.7 CEER, otherwise they shall be 10.7 EER or 10.6 CEER. Heating equipment shall be at least 95 AFUE for furnaces and 90 AFUE for boilers. Window units are not allowed. Electric resistance heating is not allowed as the primary heating source for new construction or adaptive reuse and must be approved at time of application if proposed for an Acquisition/Rehab or rehab project. AC sleeves shall be provided with a tight-fitting, insulated cover for thru wall AC units. Winter covers shall be provided for each AC unit. IFA may approve existing projects with electric resistance heating prior to Application submittal. 2. Water Heaters.

- a. In-unit water heaters that have a minimum energy factor (EF) of 0.61 for tank-type gas, 0.93 for tank-type electric, or 0.96 for tankless water heaters.
- b. Central water heaters (serving entire building) with a 90% Thermal Efficiency rating or minimum 95% efficient thermal water storage tanks coupled to a better than 90 AFUE boiler.

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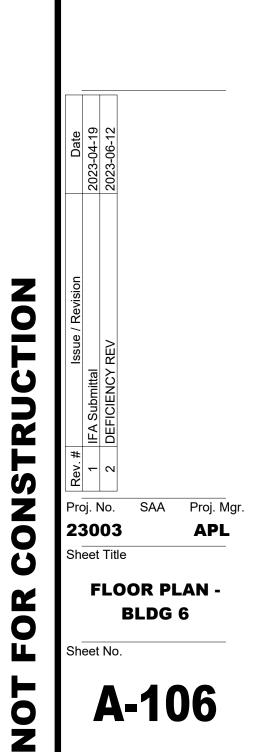
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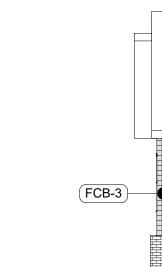


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BLDG 1 - NORTH ELEVATION

SCALE: 1/8" = 1'-0"







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- 3. ALL HORIZONTAL TRANSITIONS BETWEEN DIFFERENT MATERIALS SHALL BE FLASHED CONTINUOUS FROM UP BEHIND UPPER MATERIAL AND EXTEND OVER TO EXTERIOR FACE OF LOWER MATERIAL WITH DRIP EDGE.
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- 5. NO EXPOSED MASONRY/MATERIAL CORES. MASONRY RETURNS AT WINDOWS/OPENINGS ARE REQUIRED IF FRAMING IS NOT DEEP ENOUGH TO PROVIDE CLOSURE AT THE BACKSIDE OF MASONRY FOR AN EFFECTIVELY SEALED JOINT.
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- 9. CAULK & SEAL ALL TRANSITION-CONTROL-EXPANSION AT ALL EXTERIOR MATERIALS.
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MISC EXTERIOR MATERIAL FINISHES

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- MECHANICAL EQUIPMENT: IF NOT SCREENED, COLOR TO MATCH ADJACENT MATERIAL.
- EXTERIOR UTILITY EQUIPMENT: IF ALLOWED, PAINTED TO MATCH ADJACENT MATERIAL.
- TRIM SIZES, TYP. U.O.N.: WINDOWS & DOORS 5-1/2" VERTICAL 5-1/2"

HORIZONTAL 9-1/4"

2023 9% IFA LIHTC EXTERIOR ELEVATION REQUIREMENTS

PART A – APPLICATION REQUIREMENTS SECTION 6. SCORING CRITERIA

6.3 Market Appeal

F. Exterior Materials:

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PART C – CONSTRUCTION REQUIREMENTS SECTION 14. PRIOR TO INITIATION OF CONSTRUCTION 14.6. Minimum Development Characteristics

B. Exterior Construction

- 1. Exterior Design. The Project shall have a building design that is appealing and appropriate for the community and neighborhood, including varied facades, rooflines, and exterior materials. 2. Exterior Siding. Exterior siding shall be durable and impact-resistant. Vinyl does not qualify as durable.
- Exterior siding shall be a mix of 2 or more of the following (no single material shall constitute more than 70% of the siding): brick, fiber cement board siding, or engineered wood siding with quality standards similar to Smartside, and/or nominal, 2" nominal thickness manufactured stone over ¾" stucco, nail on stone panels or metal siding approved by IFA. The soffit and fascia shall be pre-finished aluminum, fiber
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- thickness and a 10 year full warranty. Full warranty includes: all labor and materials for the entire roofing system and insurance rider for consequential damage. All reroofing applications shall include the removal of the existing roofing system down to the roof deck. 5. **Unit Doors**. Any Unit primary entry door may be solid core wood or solid wood panel type, insulated
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EXTERIOR N	MATERIAL	LEGEND

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FCB-2	FIBER CEMENT LAP SIDING, BOARD & BATTEN, COLOR - WHITE
FCB-3	FIBER CEMENT LAP SIDING, 6" REVEAL, COLOR - LIGHT GRAY
TRM	FIBER CEMENT TRIM BOARD, SMOOTH, COLOR - WHITE







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2023 9% IFA LIHTC EXTERIOR ELEVATION REQUIREMENTS

PART A – APPLICATION REQUIREMENTS SECTION 6. SCORING CRITERIA

6.3 Market Appeal

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PART C – CONSTRUCTION REQUIREMENTS SECTION 14. PRIOR TO INITIATION OF CONSTRUCTION 14.6. Minimum Development Characteristics

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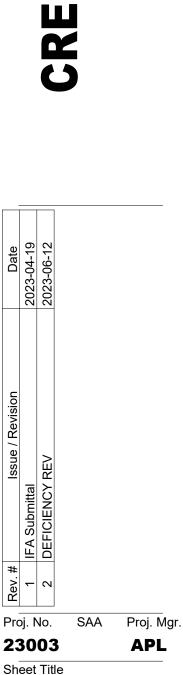








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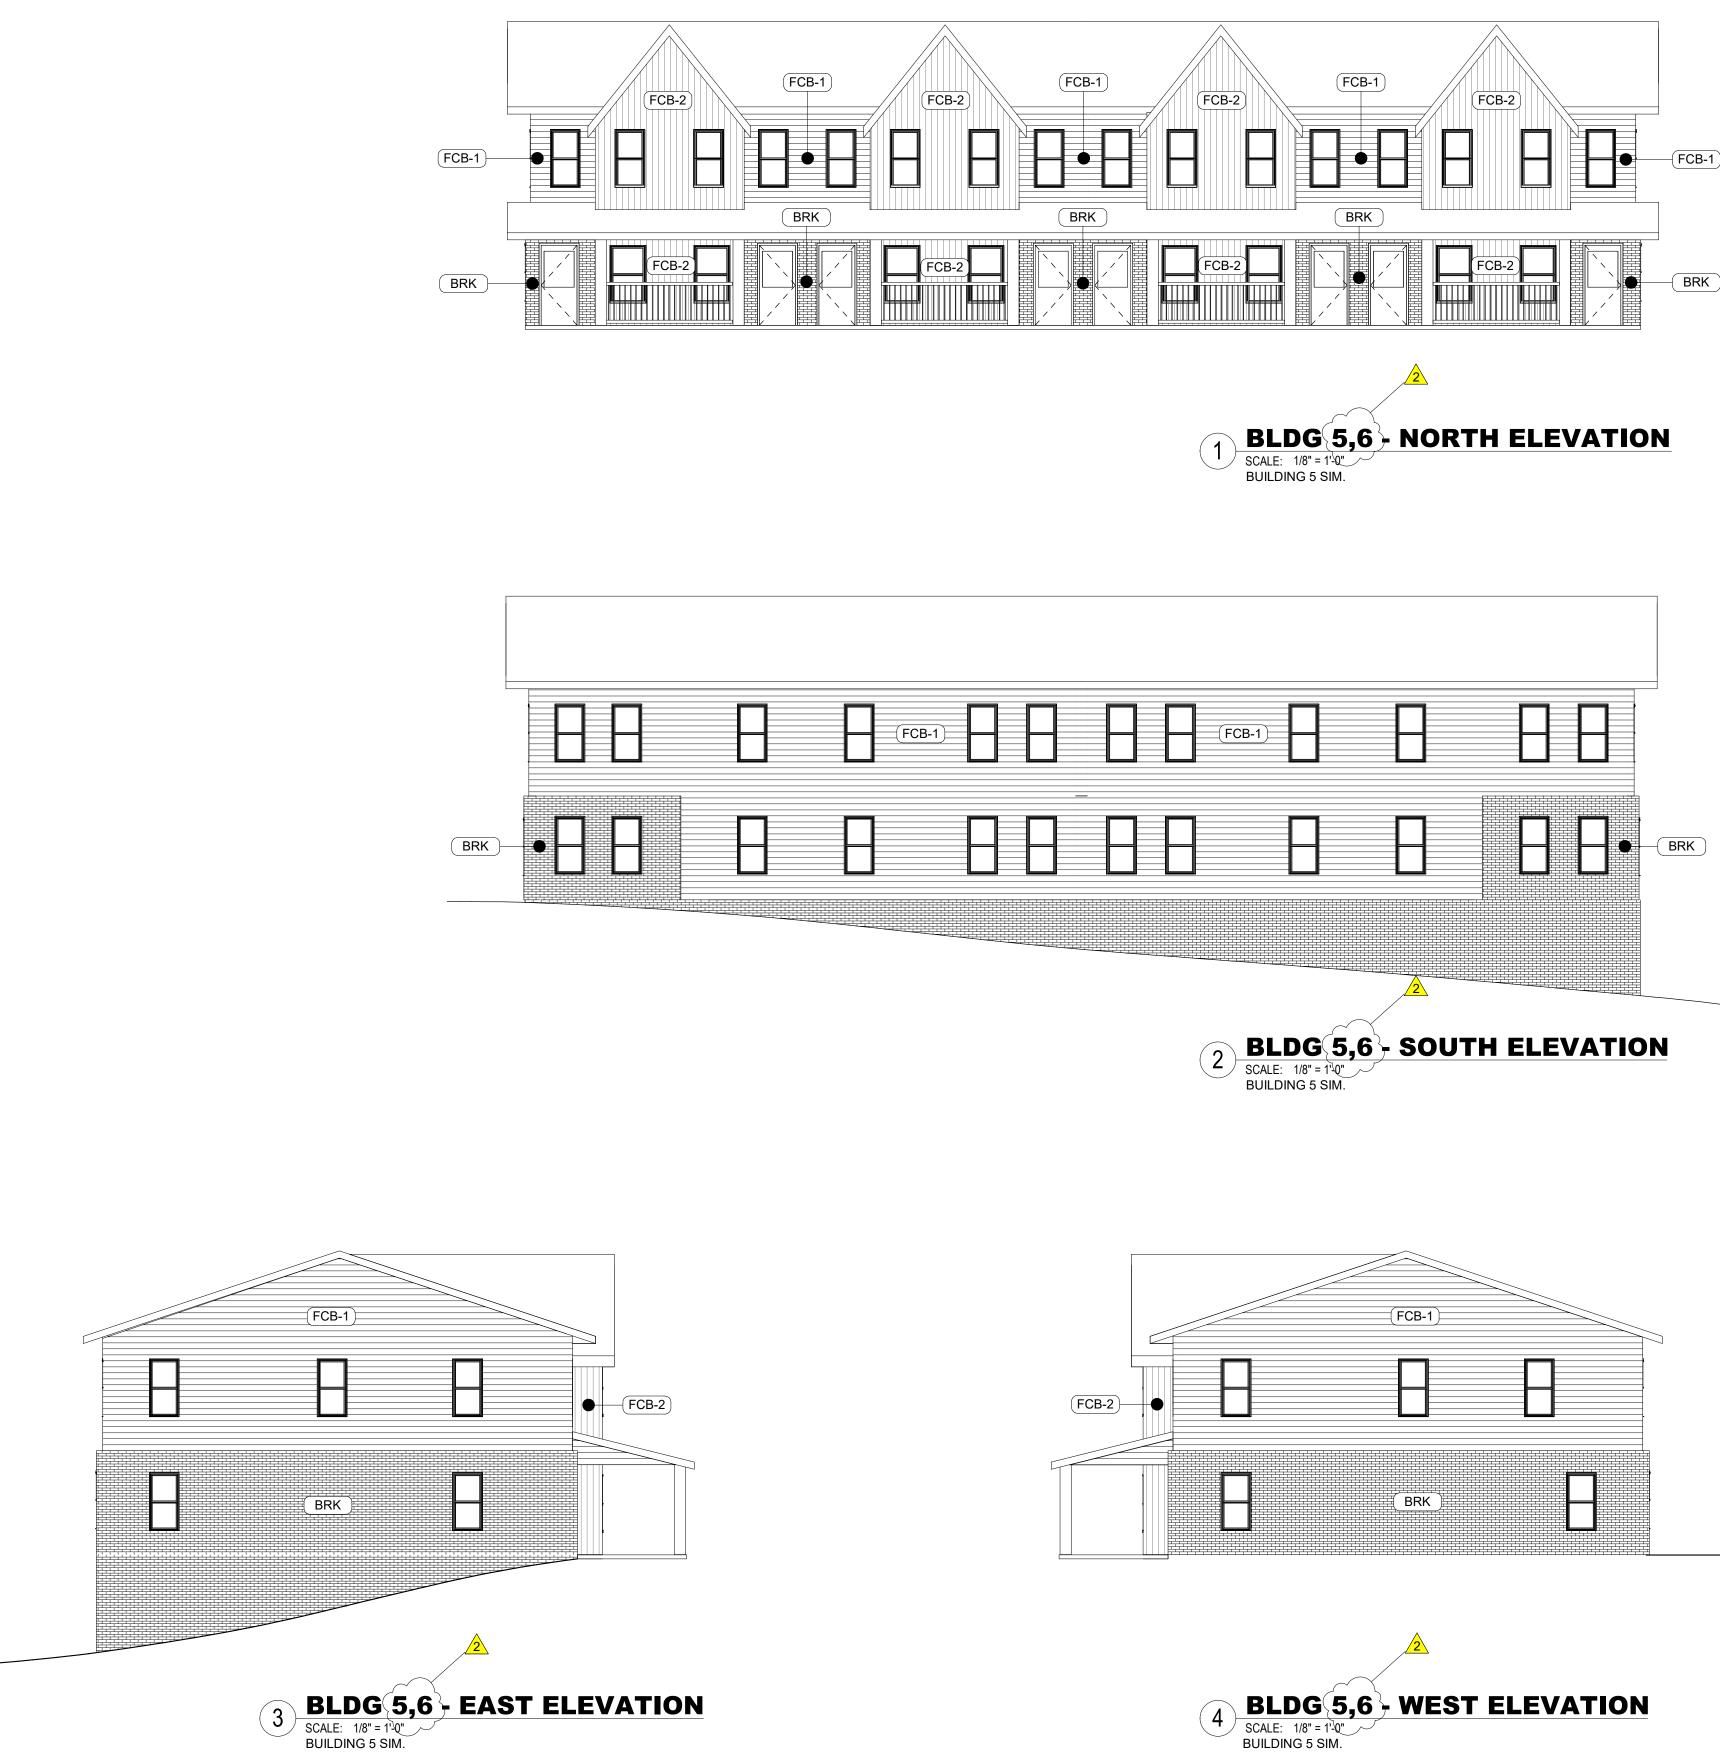
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EXTERIOR ELEVATIONS -BLDG 2, 3, & 4

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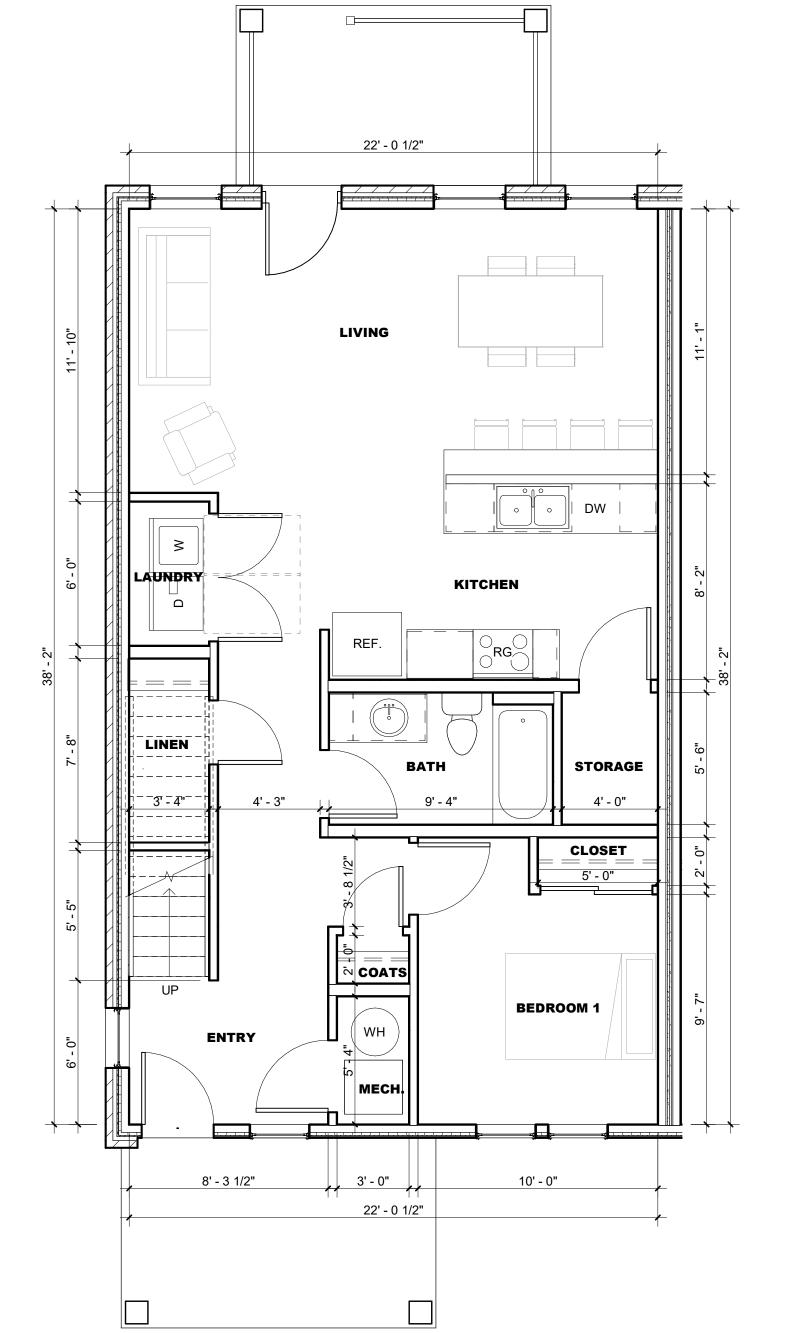
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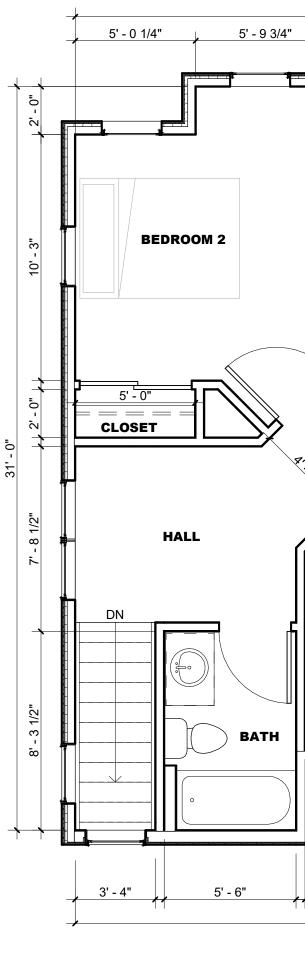
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UNIT PLAN LEGEND

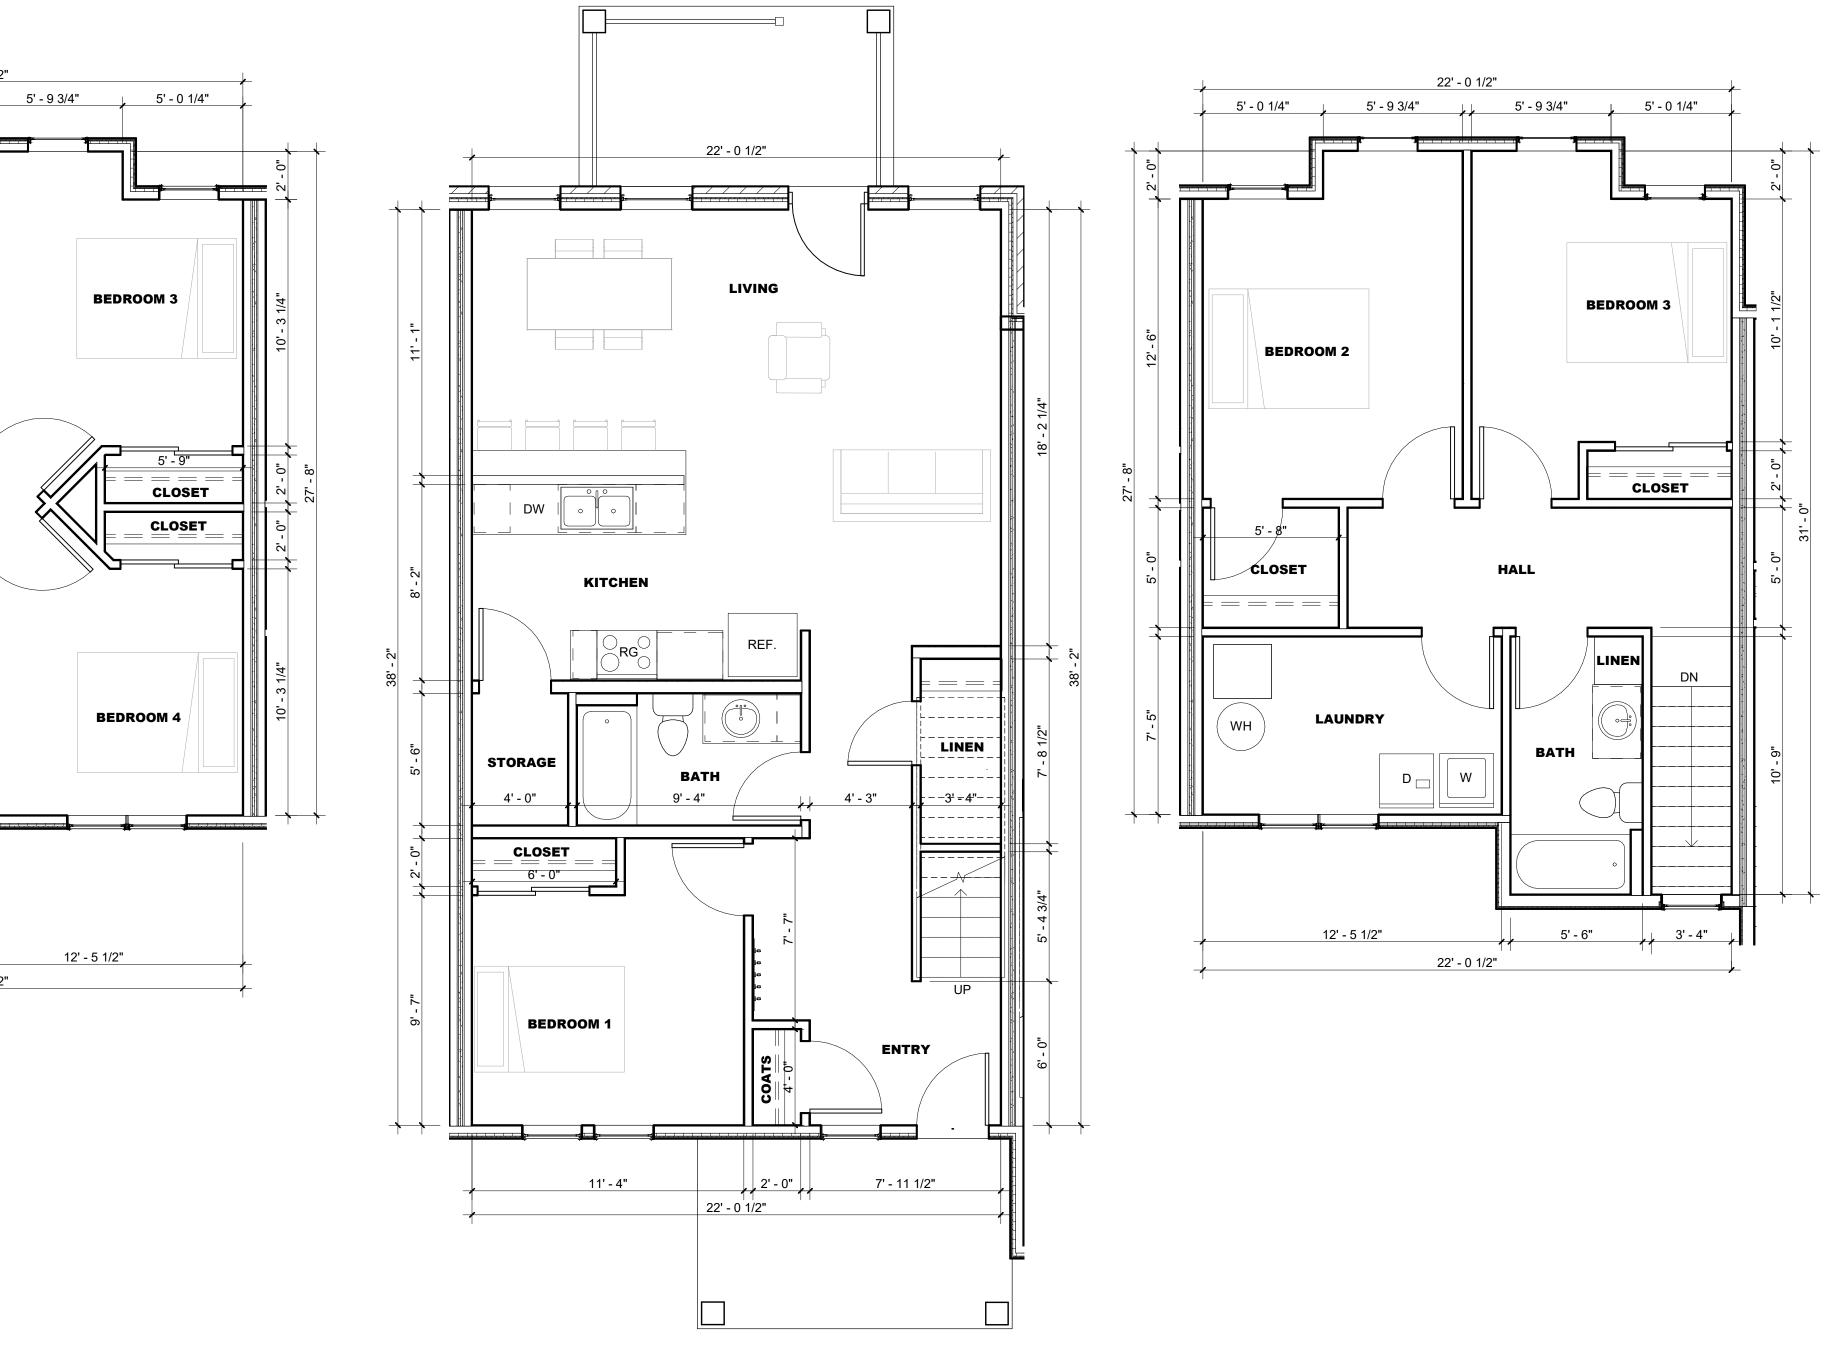
- **DW** BUILT-IN DISHWASHER
- DRYER D
- UNDERCOUNTER MICROWAVE MW
- REFRIGERATOR/FREEZER REF
- ELECTRIC RANGE W/ RANGE HOOD ABOVE RG
- VENTED TO OUTSIDE
- WD STACKED WASHER & DRYER
- W WASHER WS 30" WORK SURFACE

UNIT PLAN LEGEND

ACCESSIBLE ENTRANCE/TURN ---- ACCESSIBLE ROUTE

GENERAL UNIT PLAN NOTES

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- 2. ALL FURNITURE, FIXTURES AND EQUIPMENT SHOWN SHOULD BE CONSIDERED CONCEPTUAL AND MAY HAVE BE PROVIDED FOR COORDINATION PURPOSES ONLY. REFER TO FIRE SUPPRESSION, PLUMBING, MECHANICAL, ELECTRICAL, COMMUNICATIONS, ELECTRONIC SAFETY & SECURITY DOCUMENTS &/OR CONSULTANTS FOR SPECIFIC DESIGN INFORMATION & REQUIREMENTS.
- 3. DIMENSIONS ARE TO FACE OF FINISH MATERIAL AND CENTER OF DOOR UNLESS OTHERWISE SPECIFIED.
- 4. ALL CONDUITS, PIPES, WIRING, ROUGH-IN, ETC. SHOULD BE HELD AS TIGHT AS POSSIBLE TO THE ROOF OR FLOOR DECK OR SHOULD BE KEPT WITHIN INTERIOR WALL AND FLOOR/CEILING CAVITIES. NOTHING SHALL BE EXPOSED IN FINISHED SPACES, NOTHING SHALL PREVENT A SMOOTH CONTINUOUS FINISHED WALL OR CEILING AS NOTED ON THE DRAWINGS AND NO PLUMBING RAN IN EXTERIOR WALLS UNLESS PRIOR APPROVAL IS GRANTED BY THE ARCHITECT OR OWNER. PLACEMENT COORDINATION BETWEEN TRADES IS REQUIRED.
- 5. INSTALL AN EXHAUST FAN IN EACH BATHROOM AS REQUIRED BY CODE. EXTEND EXHAUST TO OUTSIDE AIR CODE REQUIREMENTS.
- 6. AT ALL UNITS WHERE THE WASHER & DRYER ARE LOCATED IN A DEDICATED CLOSET, PROVIDE A RETURN AIR GRILL IN THE WALL ABOVE THE DOOR HEADER SIZED TO PROVIDE ADEQUATE VENTILATION FOR PROPER WASHER & DRYER OPERATION. CONTRACTOR TO VERIFY COMPLIANCE OF DRYER VENT DISTANCE.
- 7. KITCHEN CABINETRY LAYOUTS ARE CONCEPTUAL ONLY. VERIFY FINAL LAYOUTS WITH OWNER PRIOR TO CONSTRUCTION.
- 8. PROVIDE ADEQUATE WOOD BLOCKING FOR MILLWORK, FIXTURES, EQUIPMENT, PLUMBING FIXTURES AND ACCESSORIES, ELECTRIC PANELS, FUTURE REQUIREMENTS, ETC.
- 9. ALL APARTMENTS ARE ANSI A-117 CH.10 TYPE B UNITS UNLESS OTHERWISE INDICATED.



2 **4 BEDROOM A - LEVEL 2** SCALE: 1/4" = 1'-0"

G. Minimum Development Characteristics

qualify

2023 9% IFA LIHTC FLOOR & UNIT PLAN REQUIREMENTS

PART C - THRESHOLD REQUIREMENTS FOR BUILDING, CONSTRUCTION, SITE & REHABILITATION

B. Exterior Construction

5. **Unit Doors.** Any Unit primary entry door may be solid core wood or solid wood panel type, insulated metal, or fiberglass panel type with optional glass insert, 180-degree peephole, lockset and deadbolt lock with 1 inch throw. Primary entry doors shall have steel frames. Metal frames at exterior doors shall be thermally broken or metal clad wood frames are acceptable at Unit entriesbleading to the exterior.

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vinyl coated steel or similar. 5. Paints and Primers, Adhesives, Caulks, and Sealants. Paints, primers, adhesives, caulks, and sealants shall comply with Federal

regulations applicable to low VOC requirements.

6. Minimum Bathroom Accessories: a. Towel bar(s) within reach of lavatory and tub/shower.

b. Toilet paper holder.

c. Shower curtain rod (if applicable). d. Mirror.

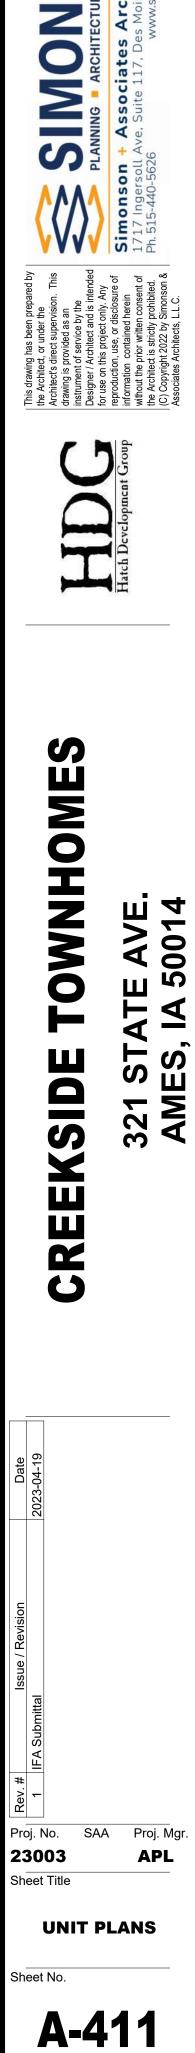
e. Cabinet with drawers, shelf space, or medicine storage cabinet. 7. Carpeting. Carpets shall be 100% nylon or nylon/olefin blend.

8. Resilient Flooring. 1/8-inch vinyl composition tile with color and pattern full thickness, LVT, sheet vinyl, linoleum flooring, tile flooring, bamboo, wood, or polished concrete.

9. **Resilient Flooring for Bathrooms**. LVT, sheet vinyl, linoleum flooring, or tile flooring.

10. Durable Window Sills. All window sills/ledges shall be composed of moisture-resistant materials, such as plastic laminate, molded plastic, cultured marble, etc. Projects with Historic tax credits may provide wood sills if they are specifically required by the State Historic Preservation Office (SHPO).

11. Window Covering. Window coverings are required. A spring-loaded type window shade is not an approved covering.



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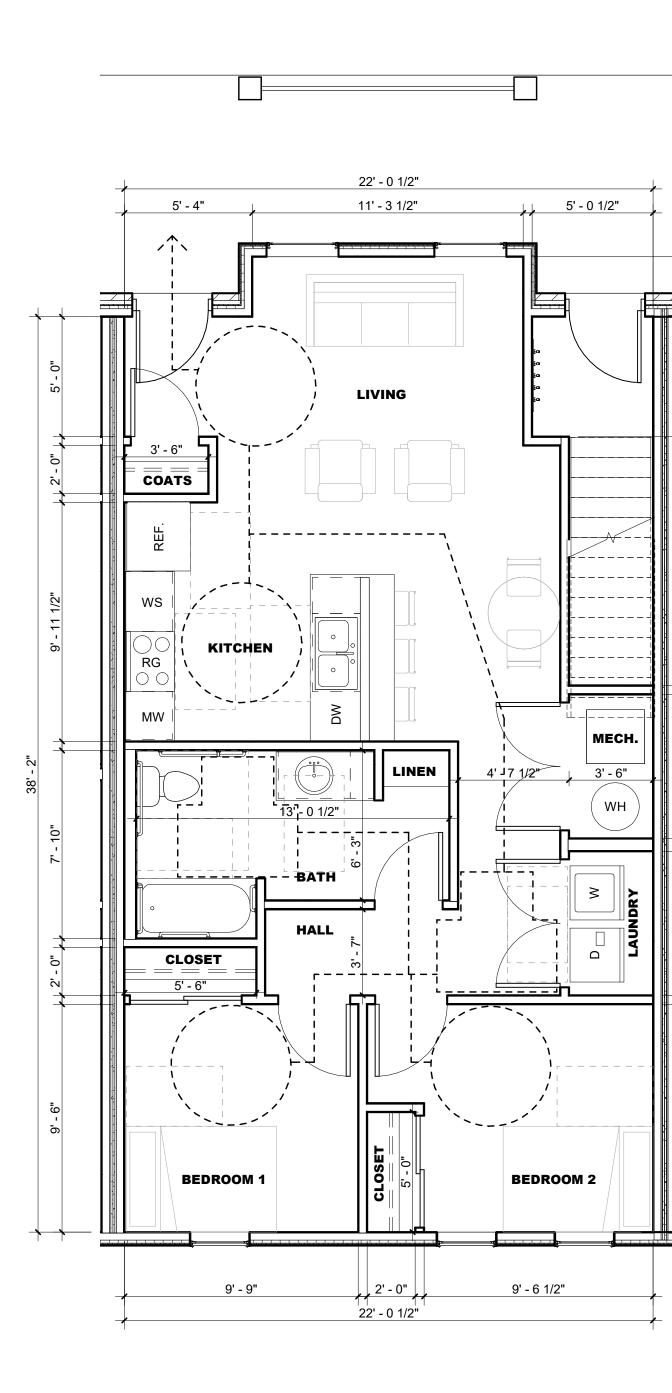
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³ **BEDROOM A - LEVEL 1** SCALE: 1/4" = 1'-0"



1 **2 BEDROOM A - LEVEL 1 (ACCESSIBLE)** SCALE: 1/4" = 1'-0"

UNIT PLAN LEGEND

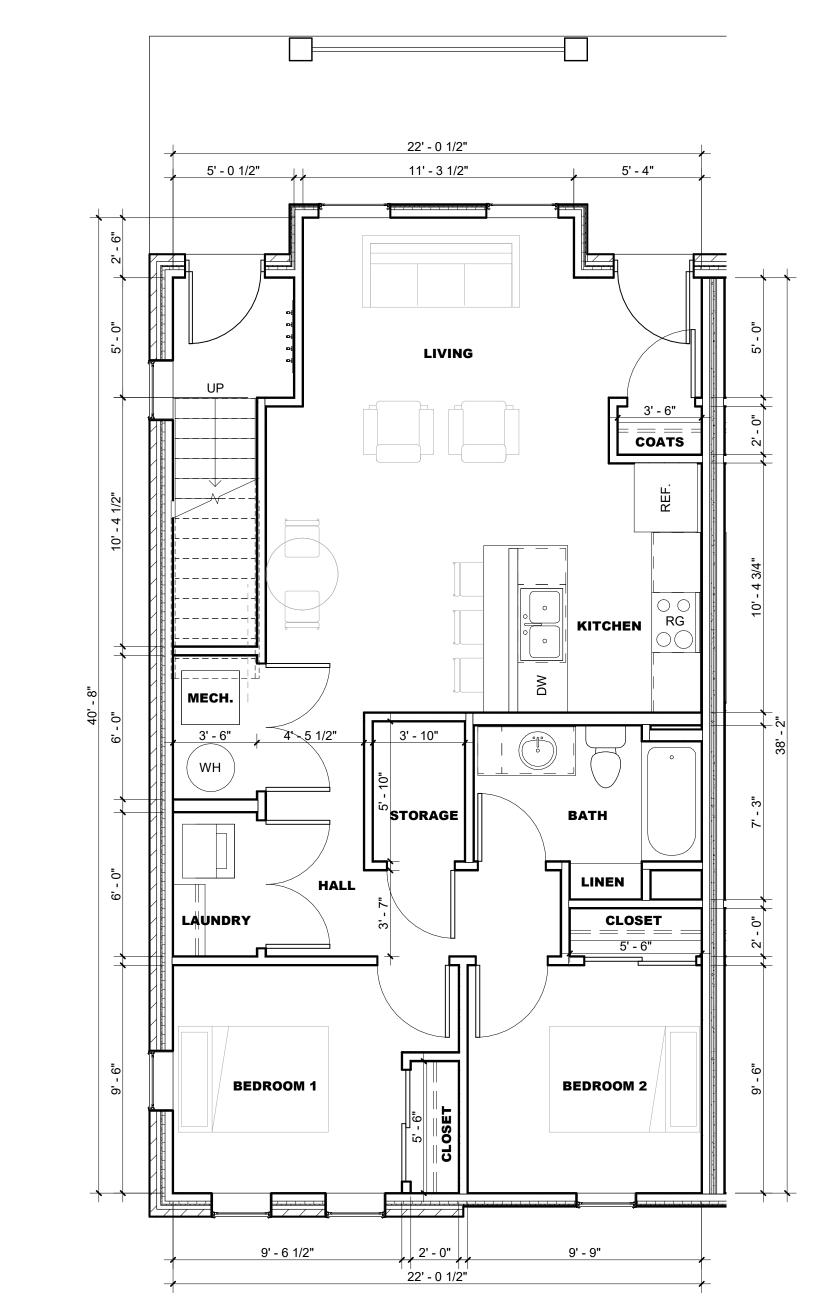
- **DW** BUILT-IN DISHWASHER
- DRYER D
- UNDERCOUNTER MICROWAVE MW
- REFRIGERATOR/FREEZER REF
- RG ELECTRIC RANGE W/ RANGE HOOD ABOVE VENTED TO OUTSIDE
- STACKED WASHER & DRYER WD
- WASHER
- 30" WORK SURFACE WS

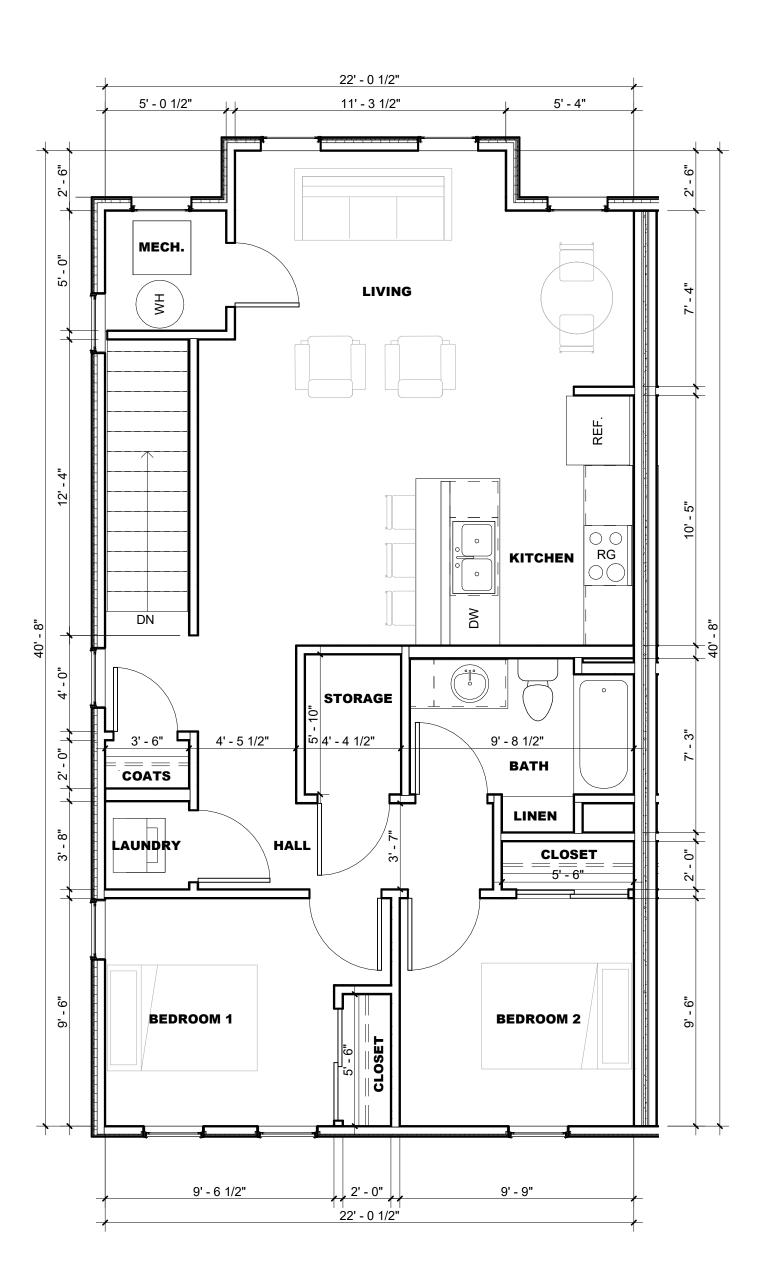
UNIT PLAN LEGEND

- ACCESSIBLE ENTRANCE/TURN
- ---- ACCESSIBLE ROUTE

GENERAL UNIT PLAN NOTES

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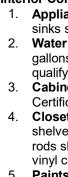






G. Minimum Development Characteristics





2023 9% IFA LIHTC FLOOR & UNIT PLAN REQUIREMENTS

PART C - THRESHOLD REQUIREMENTS FOR BUILDING, CONSTRUCTION, SITE & REHABILITATION

B. Exterior Construction

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b. Toilet paper holder. c. Shower curtain rod (if applicable).

d. Mirror.

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11. Window Covering. Window coverings are required. A spring-loaded type window shade is not an approved covering.

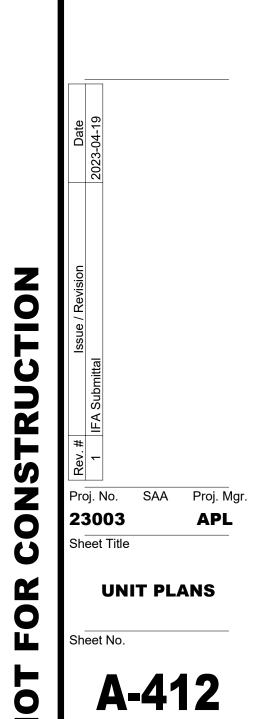






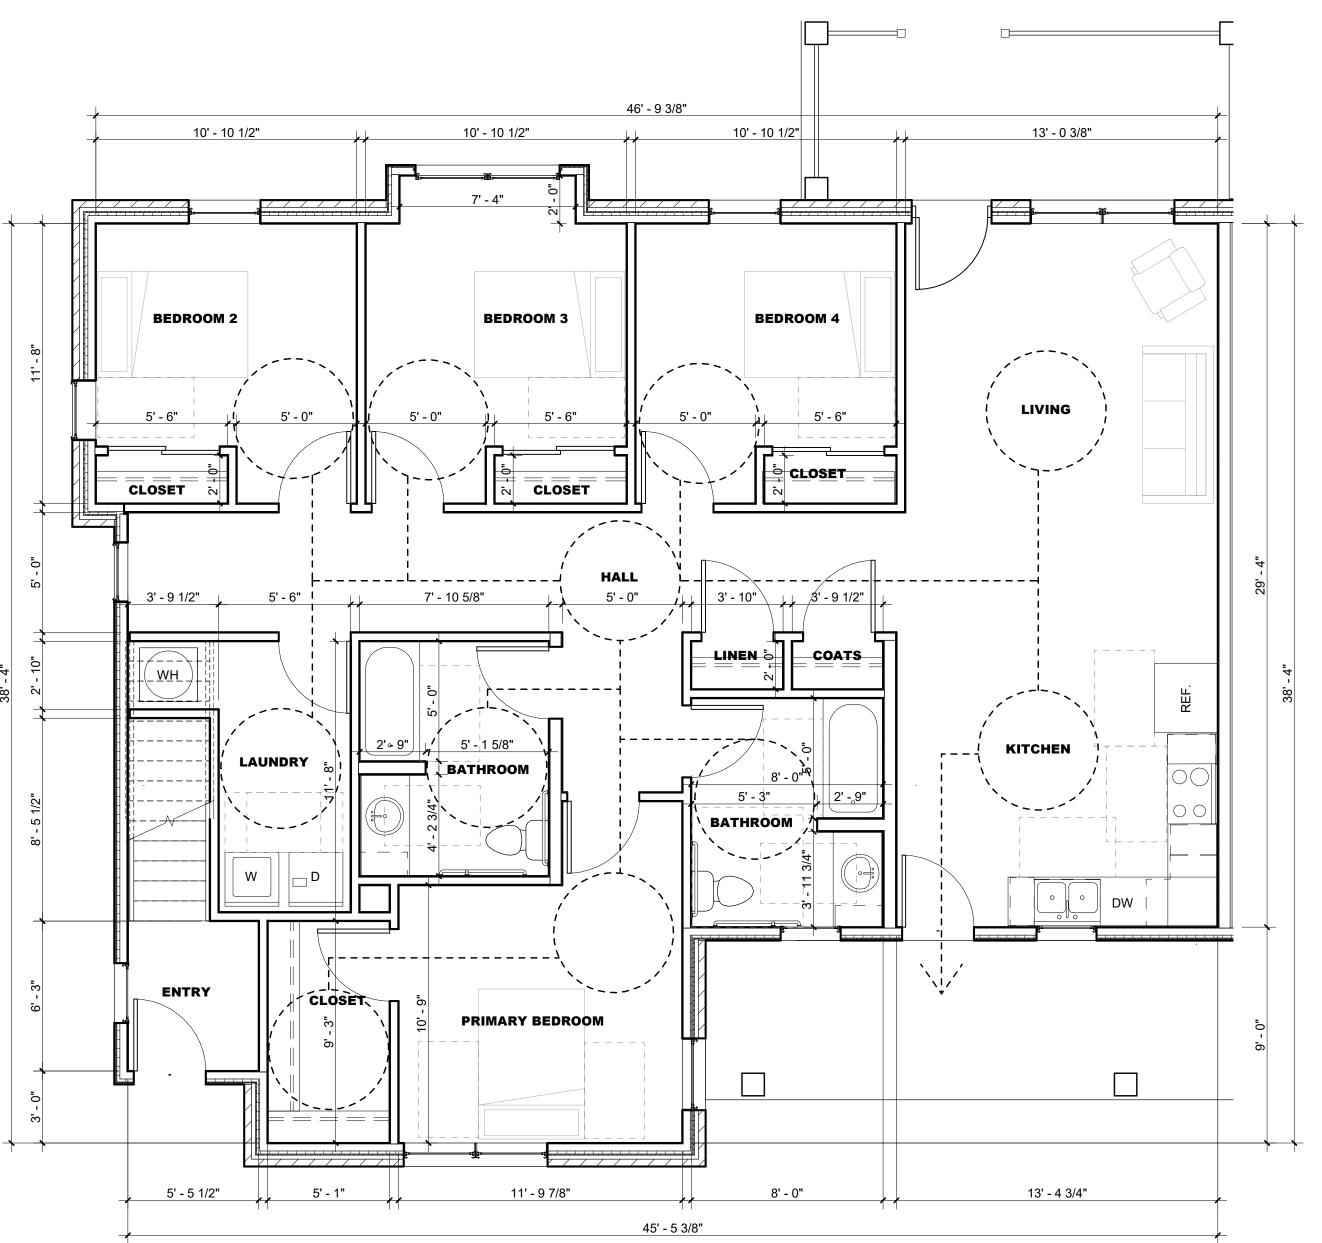


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UNIT PLAN LEGEND

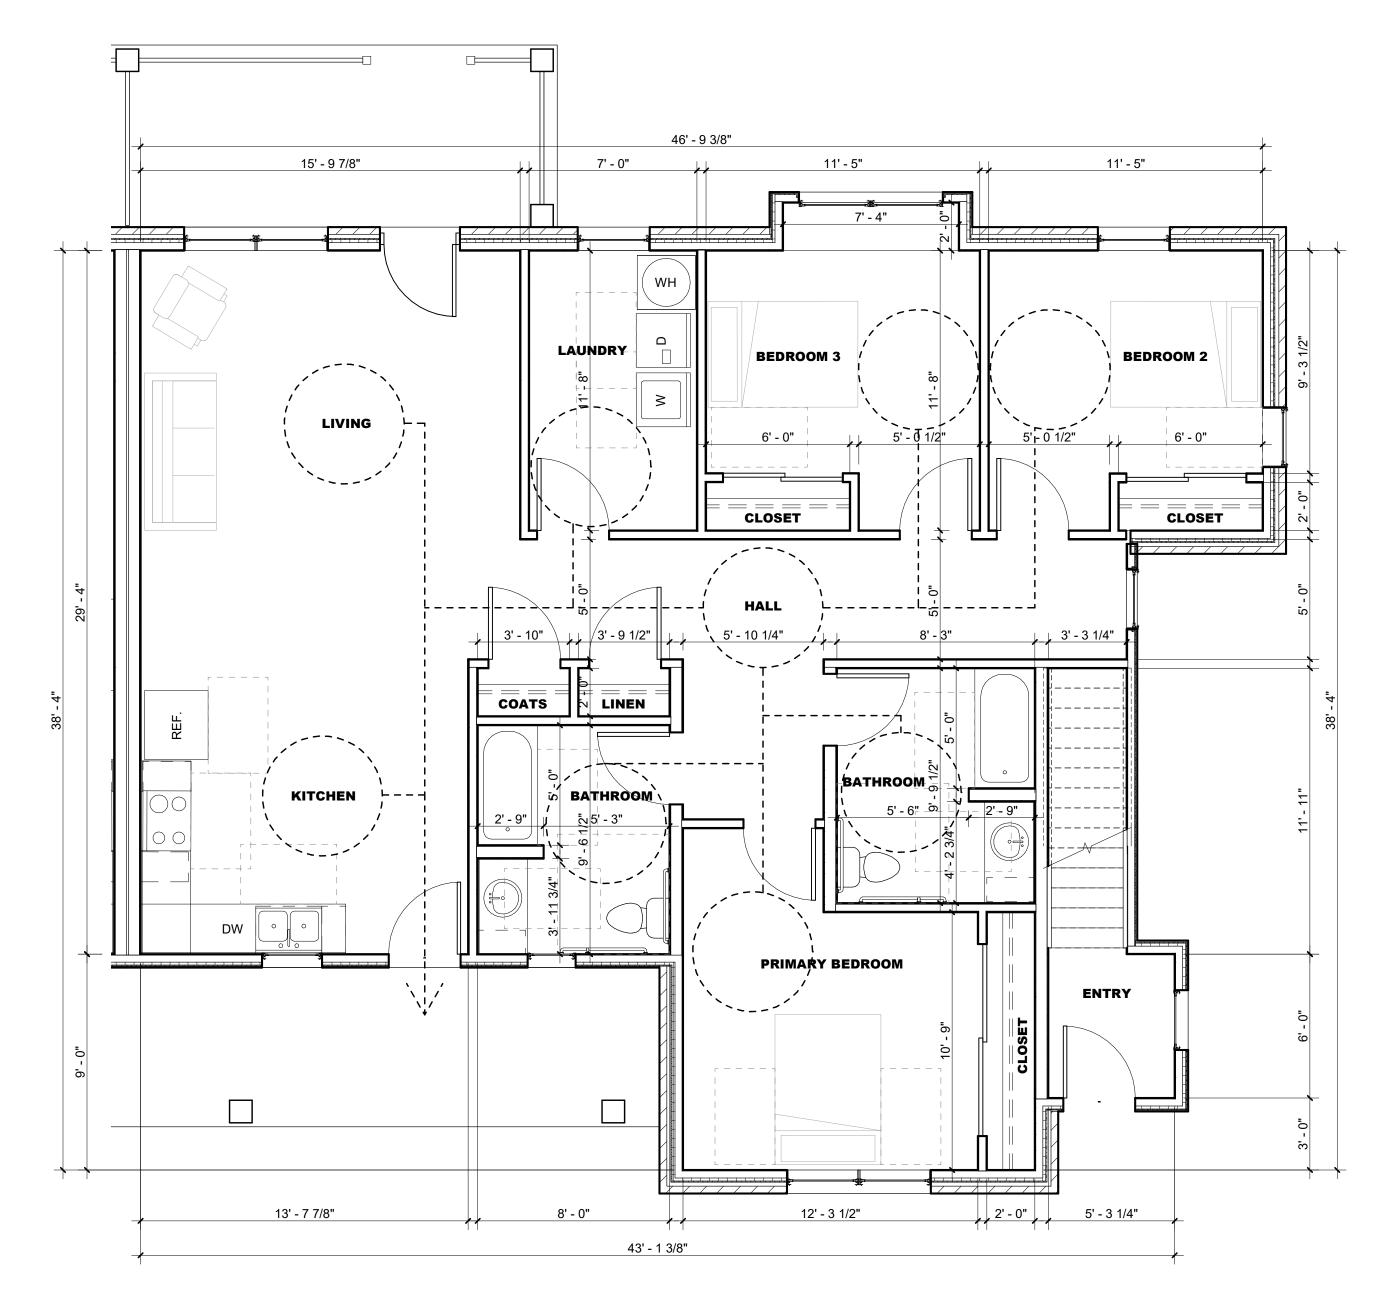
- BUILT-IN DISHWASHER DW
- DRYER D
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- REFRIGERATOR/FREEZER REF
- ELECTRIC RANGE W/ RANGE HOOD ABOVE RG
- VENTED TO OUTSIDE
- WD STACKED WASHER & DRYER
- W WASHER 30" WORK SURFACE WS

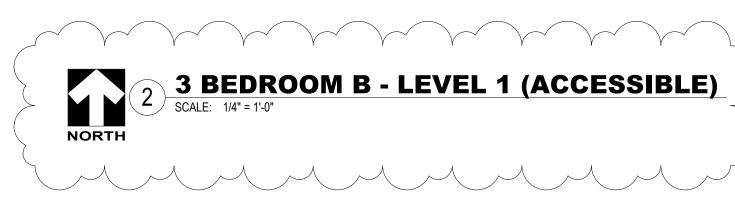
UNIT PLAN LEGEND

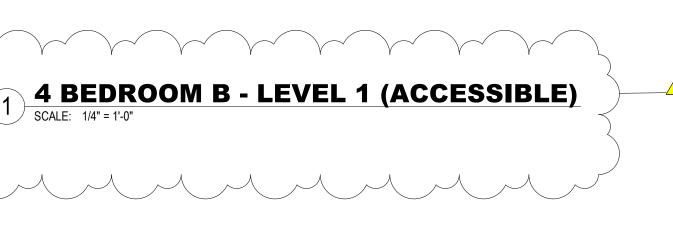
ACCESSIBLE ENTRANCE/TURN ---- ACCESSIBLE ROUTE

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- C. Interior Construction qualify.

- d. Mirror.

2023 9% IFA LIHTC FLOOR & UNIT PLAN REQUIREMENTS

PART C – THRESHOLD REQUIREMENTS FOR BUILDING, CONSTRUCTION, SITE & REHABILITATION G. Minimum Development Characteristics

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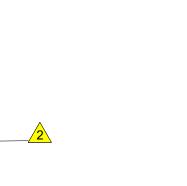
e. Cabinet with drawers, shelf space, or medicine storage cabinet. 7. **Carpeting.** Carpets shall be 100% nylon or nylon/olefin blend.

8. Resilient Flooring. 1/8-inch vinyl composition tile with color and pattern full thickness, LVT, sheet vinyl, linoleum flooring, tile flooring, bamboo, wood, or polished concrete.

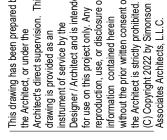
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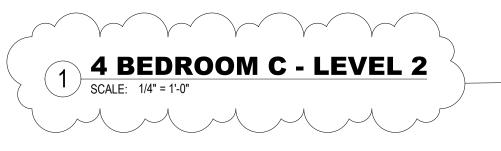
UNIT PLANS

A-413

Sheet No

Proj. No. 23003

Sheet Title





UNIT PLAN LEGEND

- **DW** BUILT-IN DISHWASHER
- D DRYER
- MW UNDERCOUNTER MICROWAVE
- REFRIGERATOR/FREEZER REF
- ELECTRIC RANGE W/ RANGE HOOD ABOVE RG VENTED TO OUTSIDE
- STACKED WASHER & DRYER WD
- W WASHER
- WS 30" WORK SURFACE

UNIT PLAN LEGEND

- ACCESSIBLE ENTRANCE/TURN
- ---- ACCESSIBLE ROUTE

GENERAL UNIT PLAN NOTES

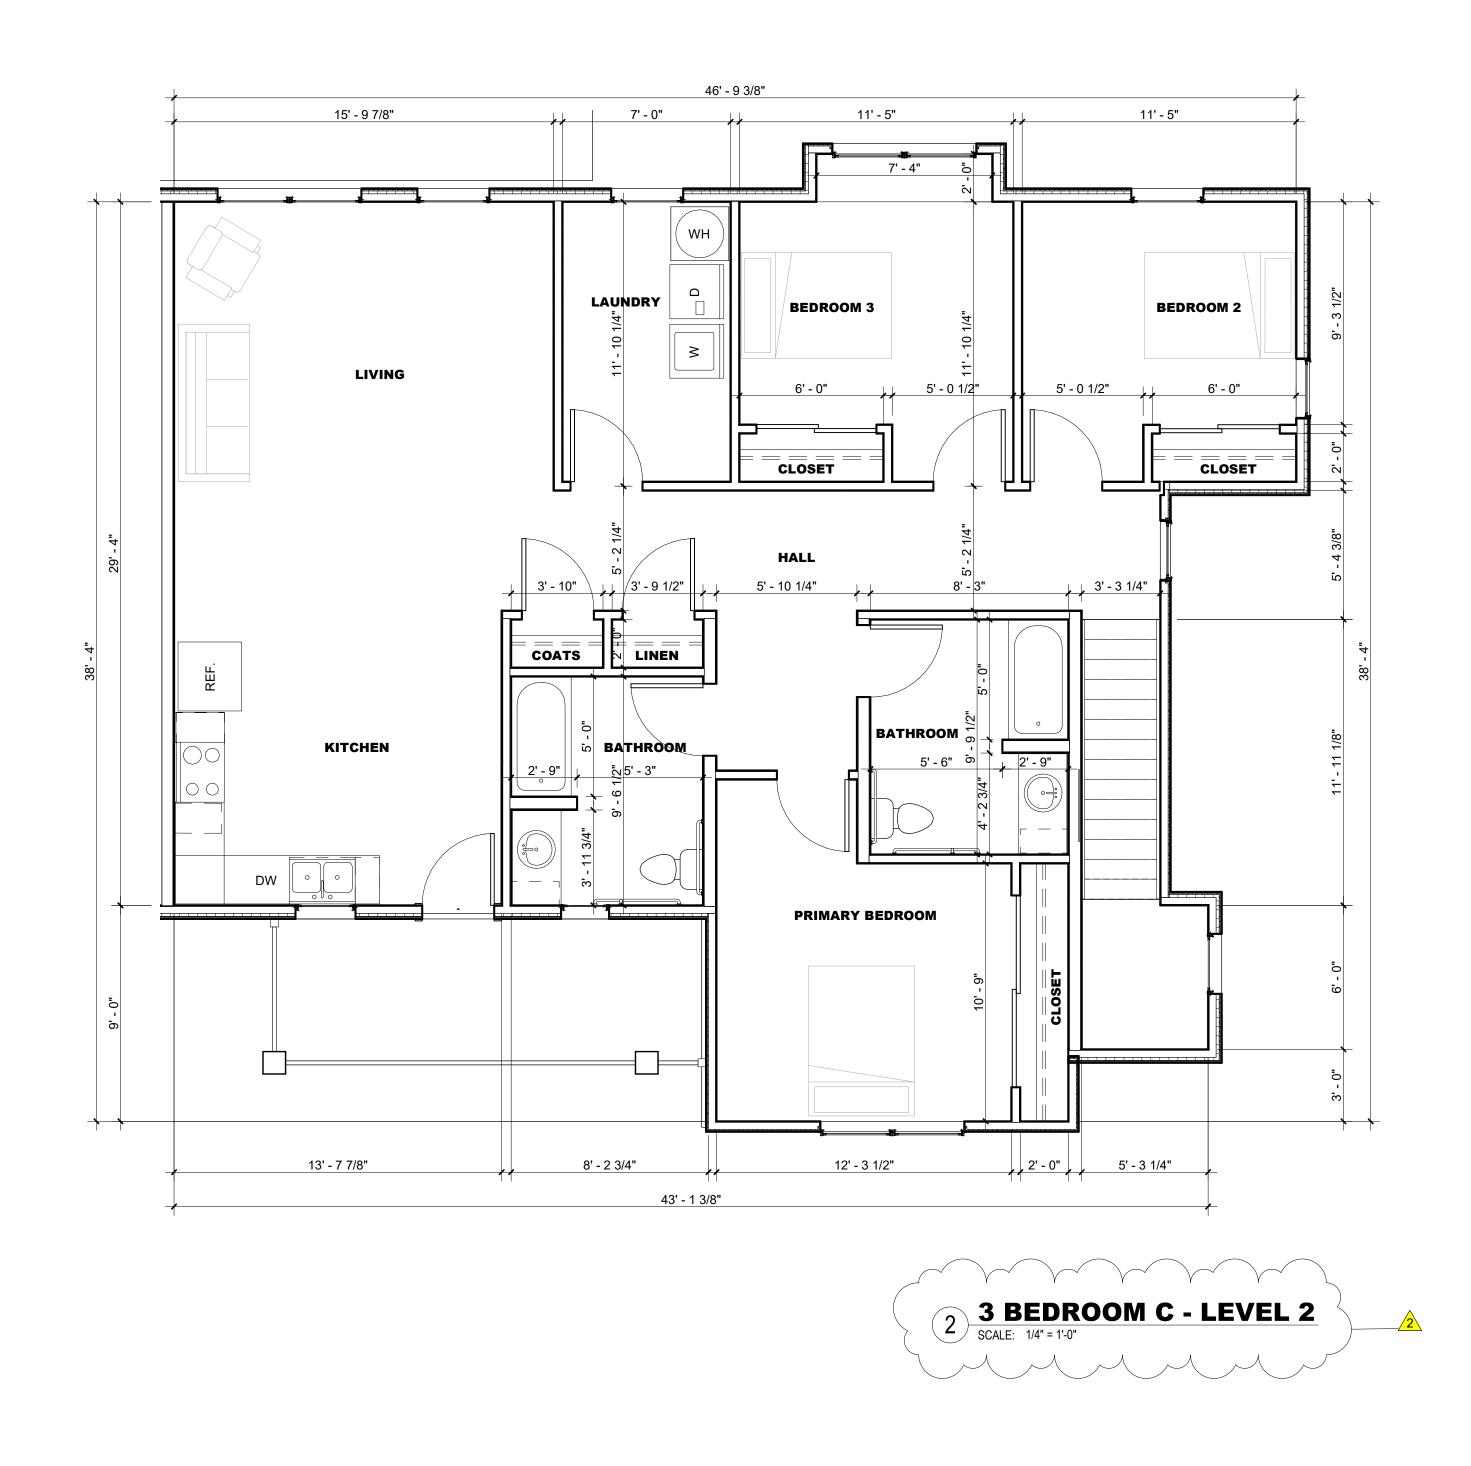
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G. Minimum Development Characteristics

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C. Inte 1.	
2.	sinks Wate

- qualify.
- b. Toilet paper holder. d. Mirror.
- Office (SHPO).



2023 9% IFA LIHTC FLOOR & UNIT PLAN REQUIREMENTS

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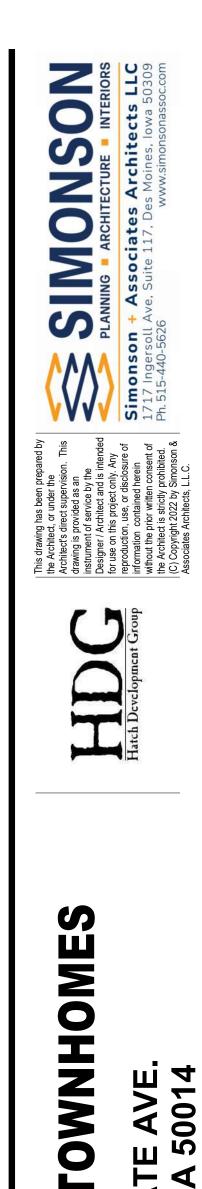
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SAA Proj. Mgr. Proj. No. 23003 Sheet Title **UNIT PLANS** Sheet No

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